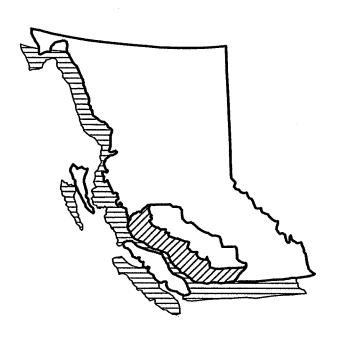


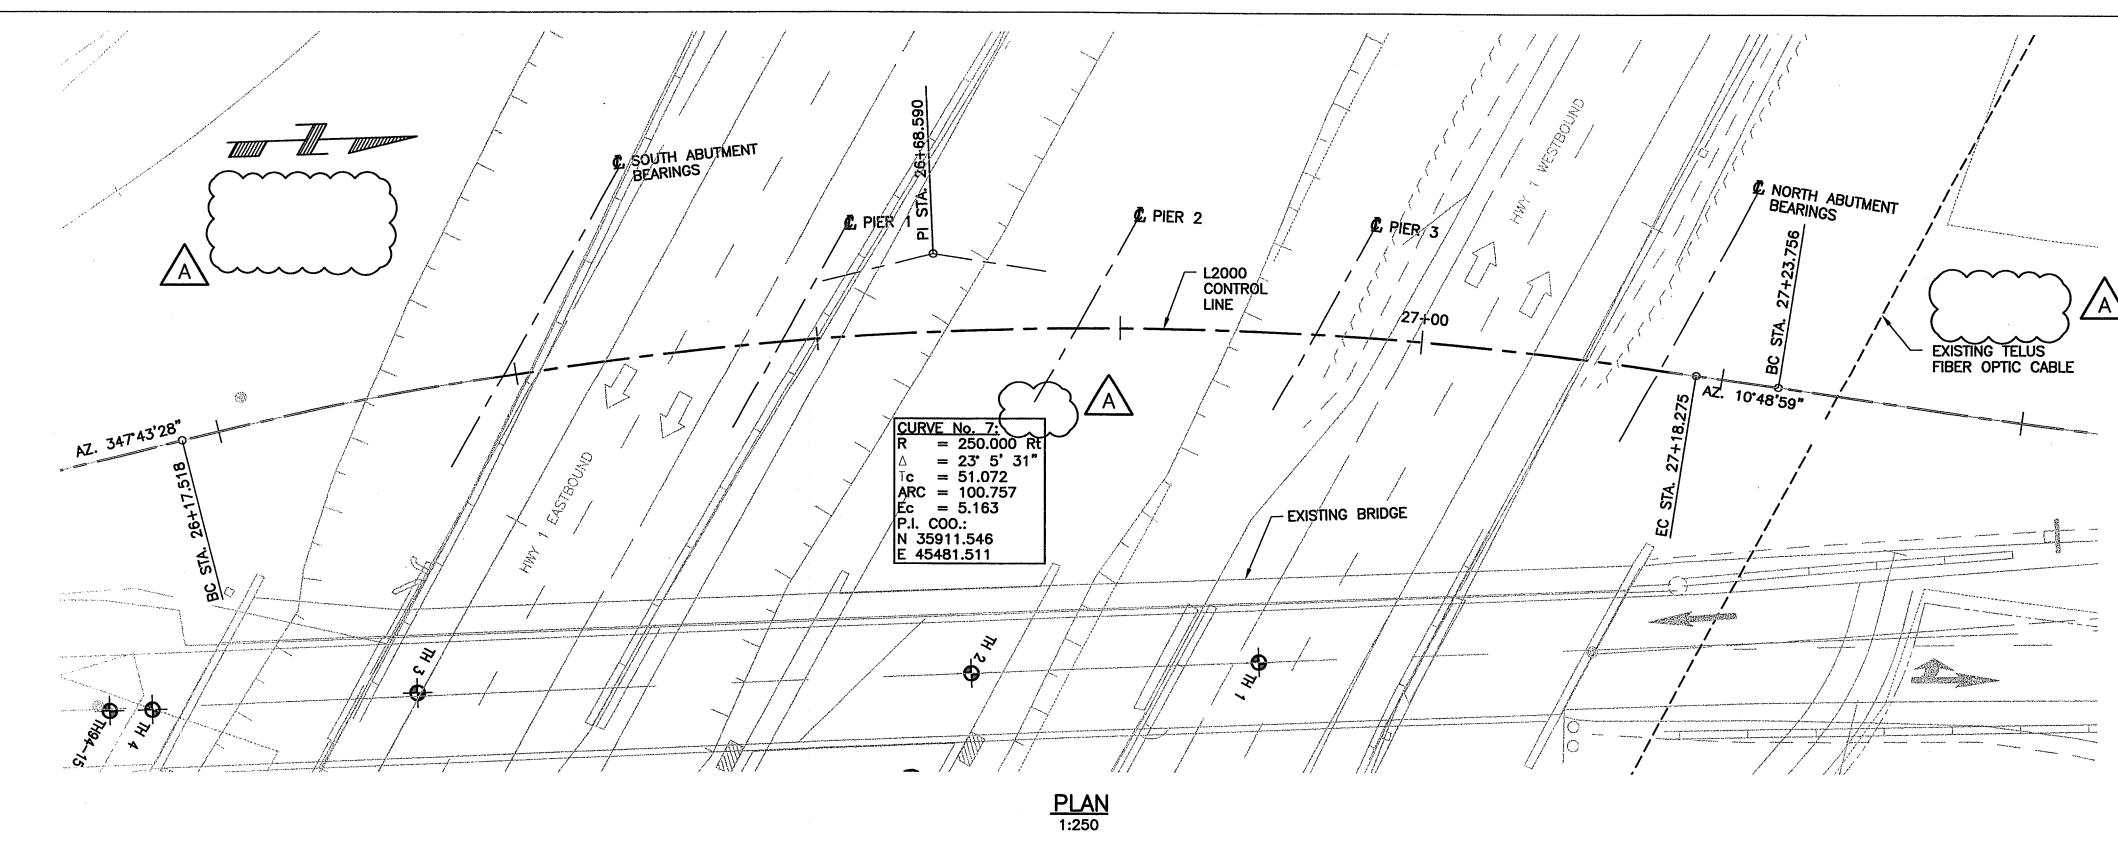


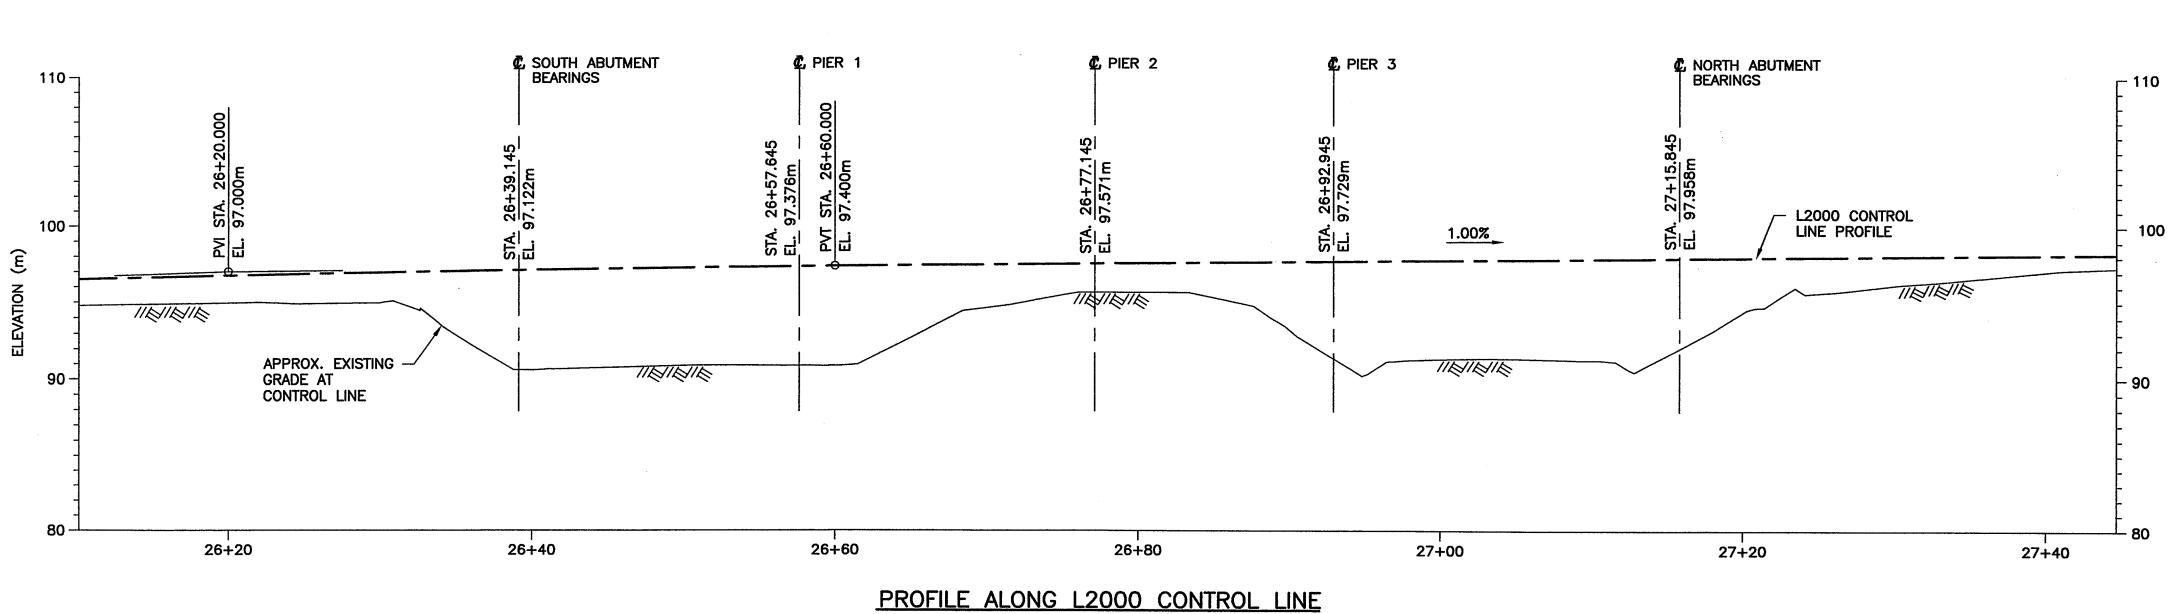
City of Abbotsford

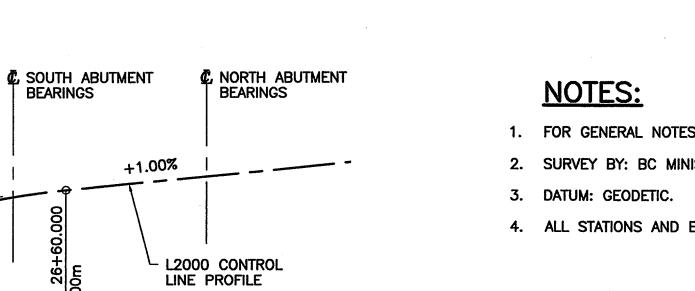
MINISTRY OF TRANSPORTATION SOUTH COAST REGION

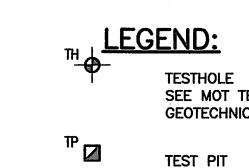
CONTRACT NO. 04-29 MT. LEHMAN UNDERPASS BRIDGE No. 1562











test pit See test pi

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PVI STA. 26+20.000 EL. 97.000m

VC = 80.000K = 31.4 PVT STA. EL. 97.40

L2000 VERTICAL ALIGNMENT

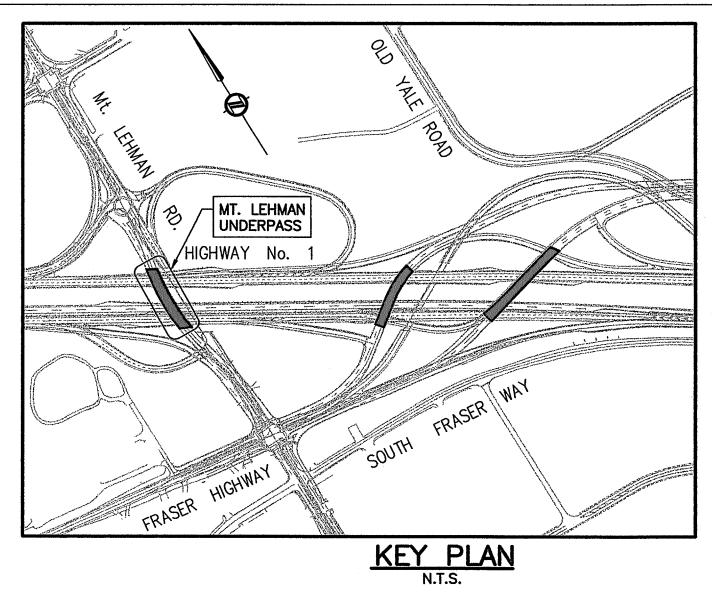
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PVC STA. 25-EL. 95.580m

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L2000 CONTROL LINE							
S SEE DRAWING 1562-102.							
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ESTHOLE LOGS (REF: FACTUAL CAL REPORT, SEPT. 5, 2000, APPENDIX C)	D			14. X.		04/11/03	ISSUED
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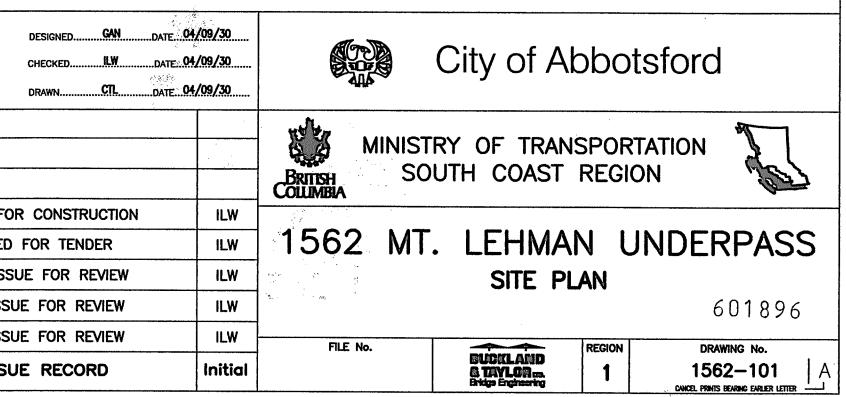


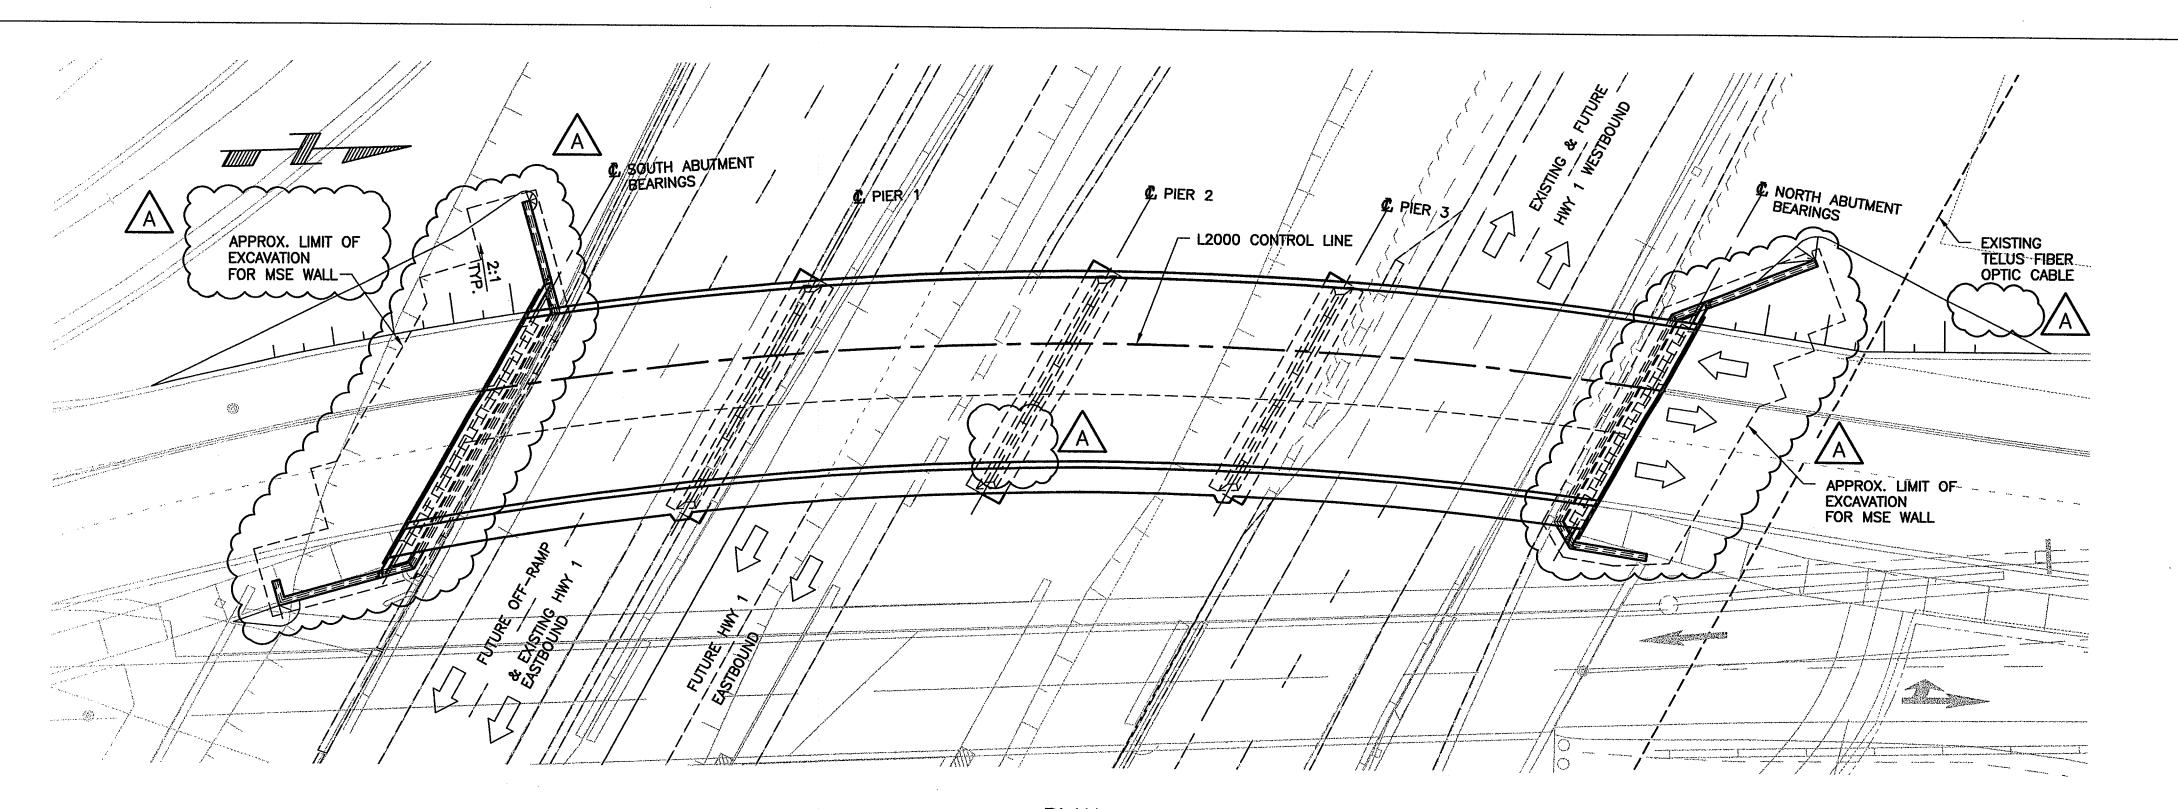
DRAWING LIST:

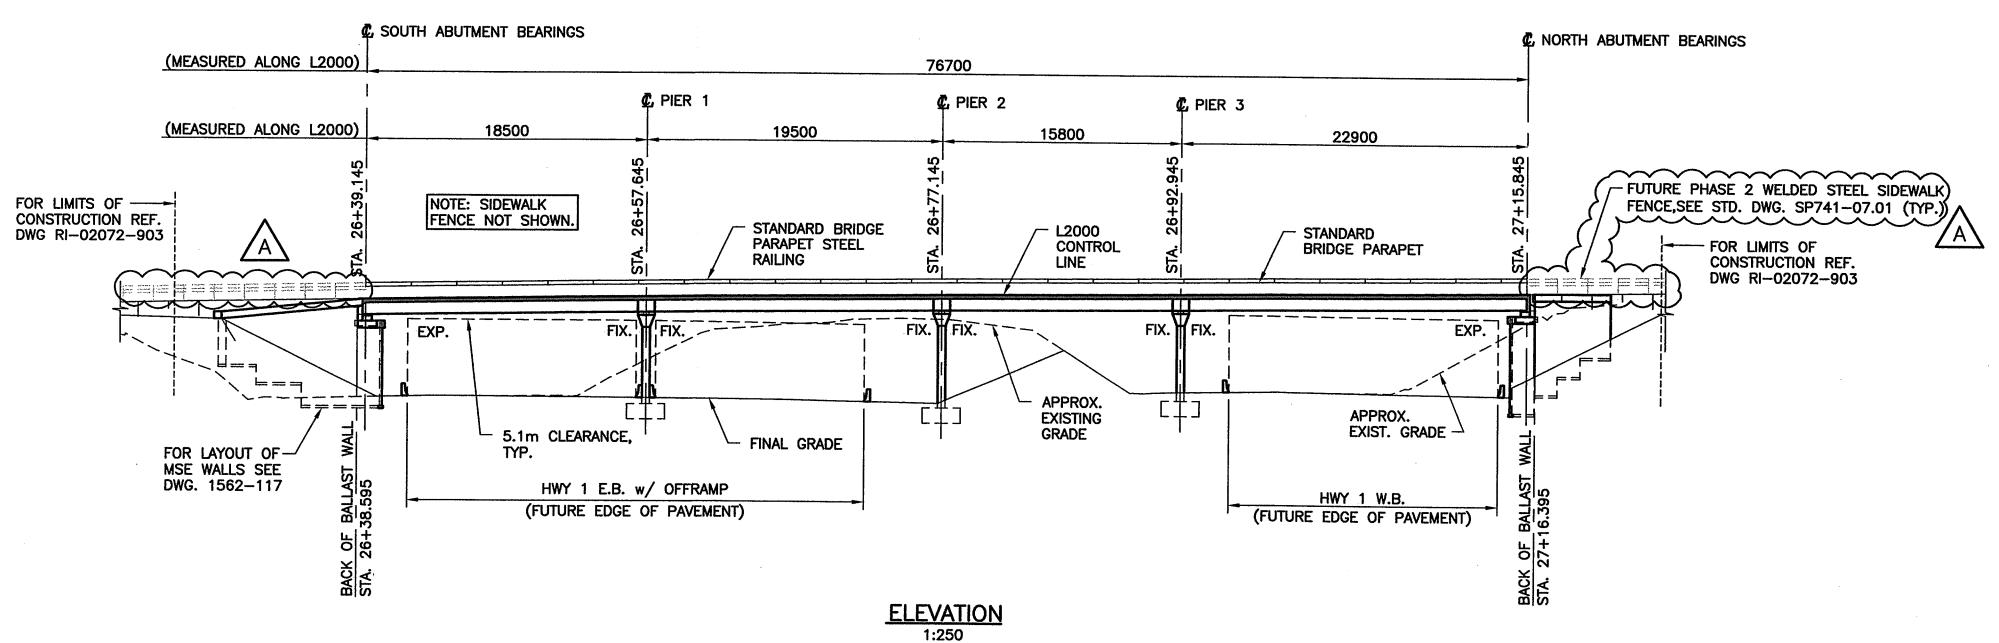
DRAWING No.	TITLE
(1562-101A)	SITE PLAN
(1562–102A)	GENERAL ARRANGEMENT
> 1562–103A >	FOUNDATION LAYOUT
2 1562-104A	FOUNDATION REINFORCEMENT
2 1562-105A	SOUTH ABUTMENT
(1562-106A)	NORTH ABUTMENT
(1562–107A)	ABUTMENT - REINFORCEMENT
> 1562-108A >	PIERS
1562−109A	PIER REINFORCEMENT
کې 1562–110A	PRECAST STRINGER LAYOUT
{ 1562-111A }	CONCRETE BOX STRINGERS MK1
() 1562–112A	CONCRETE BOX STRINGERS MK2
> 1562–113A >	CONCRETE BOX STRINGERS MK3
1562-114A	CONCRETE BOX STRINGERS MK4
(1562–115A {	DECK
∧ <a>1562-116A	DECK REINFORCEMENT
A 1562-117B	MSE WALLS

REFERENCE DRAWINGS:

DRAWING No.	<u>REV.</u>	TITLE
2784-1	Q	STANDARD BRIDGE PARAPET – 810mm HIGH
SP941-03.04.01, 02		STANDARD BRIDGE PARAPET – 810mm HIGH TRANSITION
2785-2	В	STANDARD BRIDGE PARAPET STEEL RAILING (1995)
2891-1	L	STANDARD STEEL SIDEWALK FENCE
SP741-07.01		SIDEWALK FENCE - WELDED OR SLIP-ON
SP941-02.01.05-07		PRECAST CONCRETE PIER BARRIER – 810mm CPB

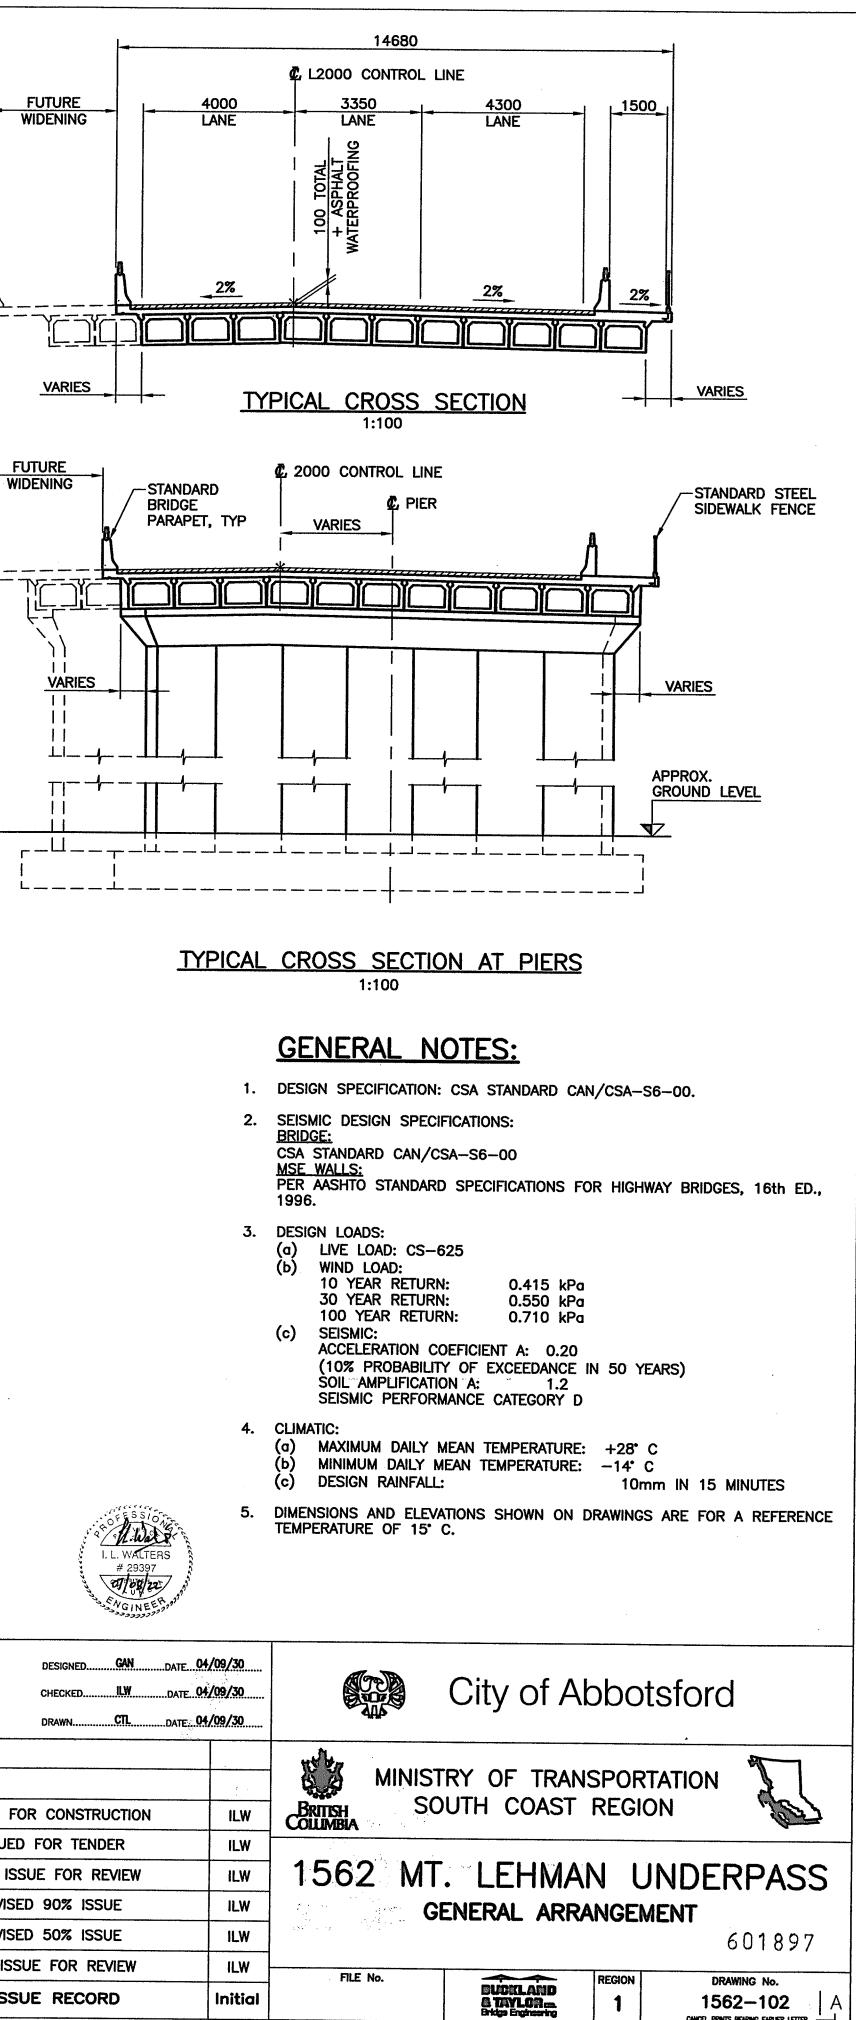






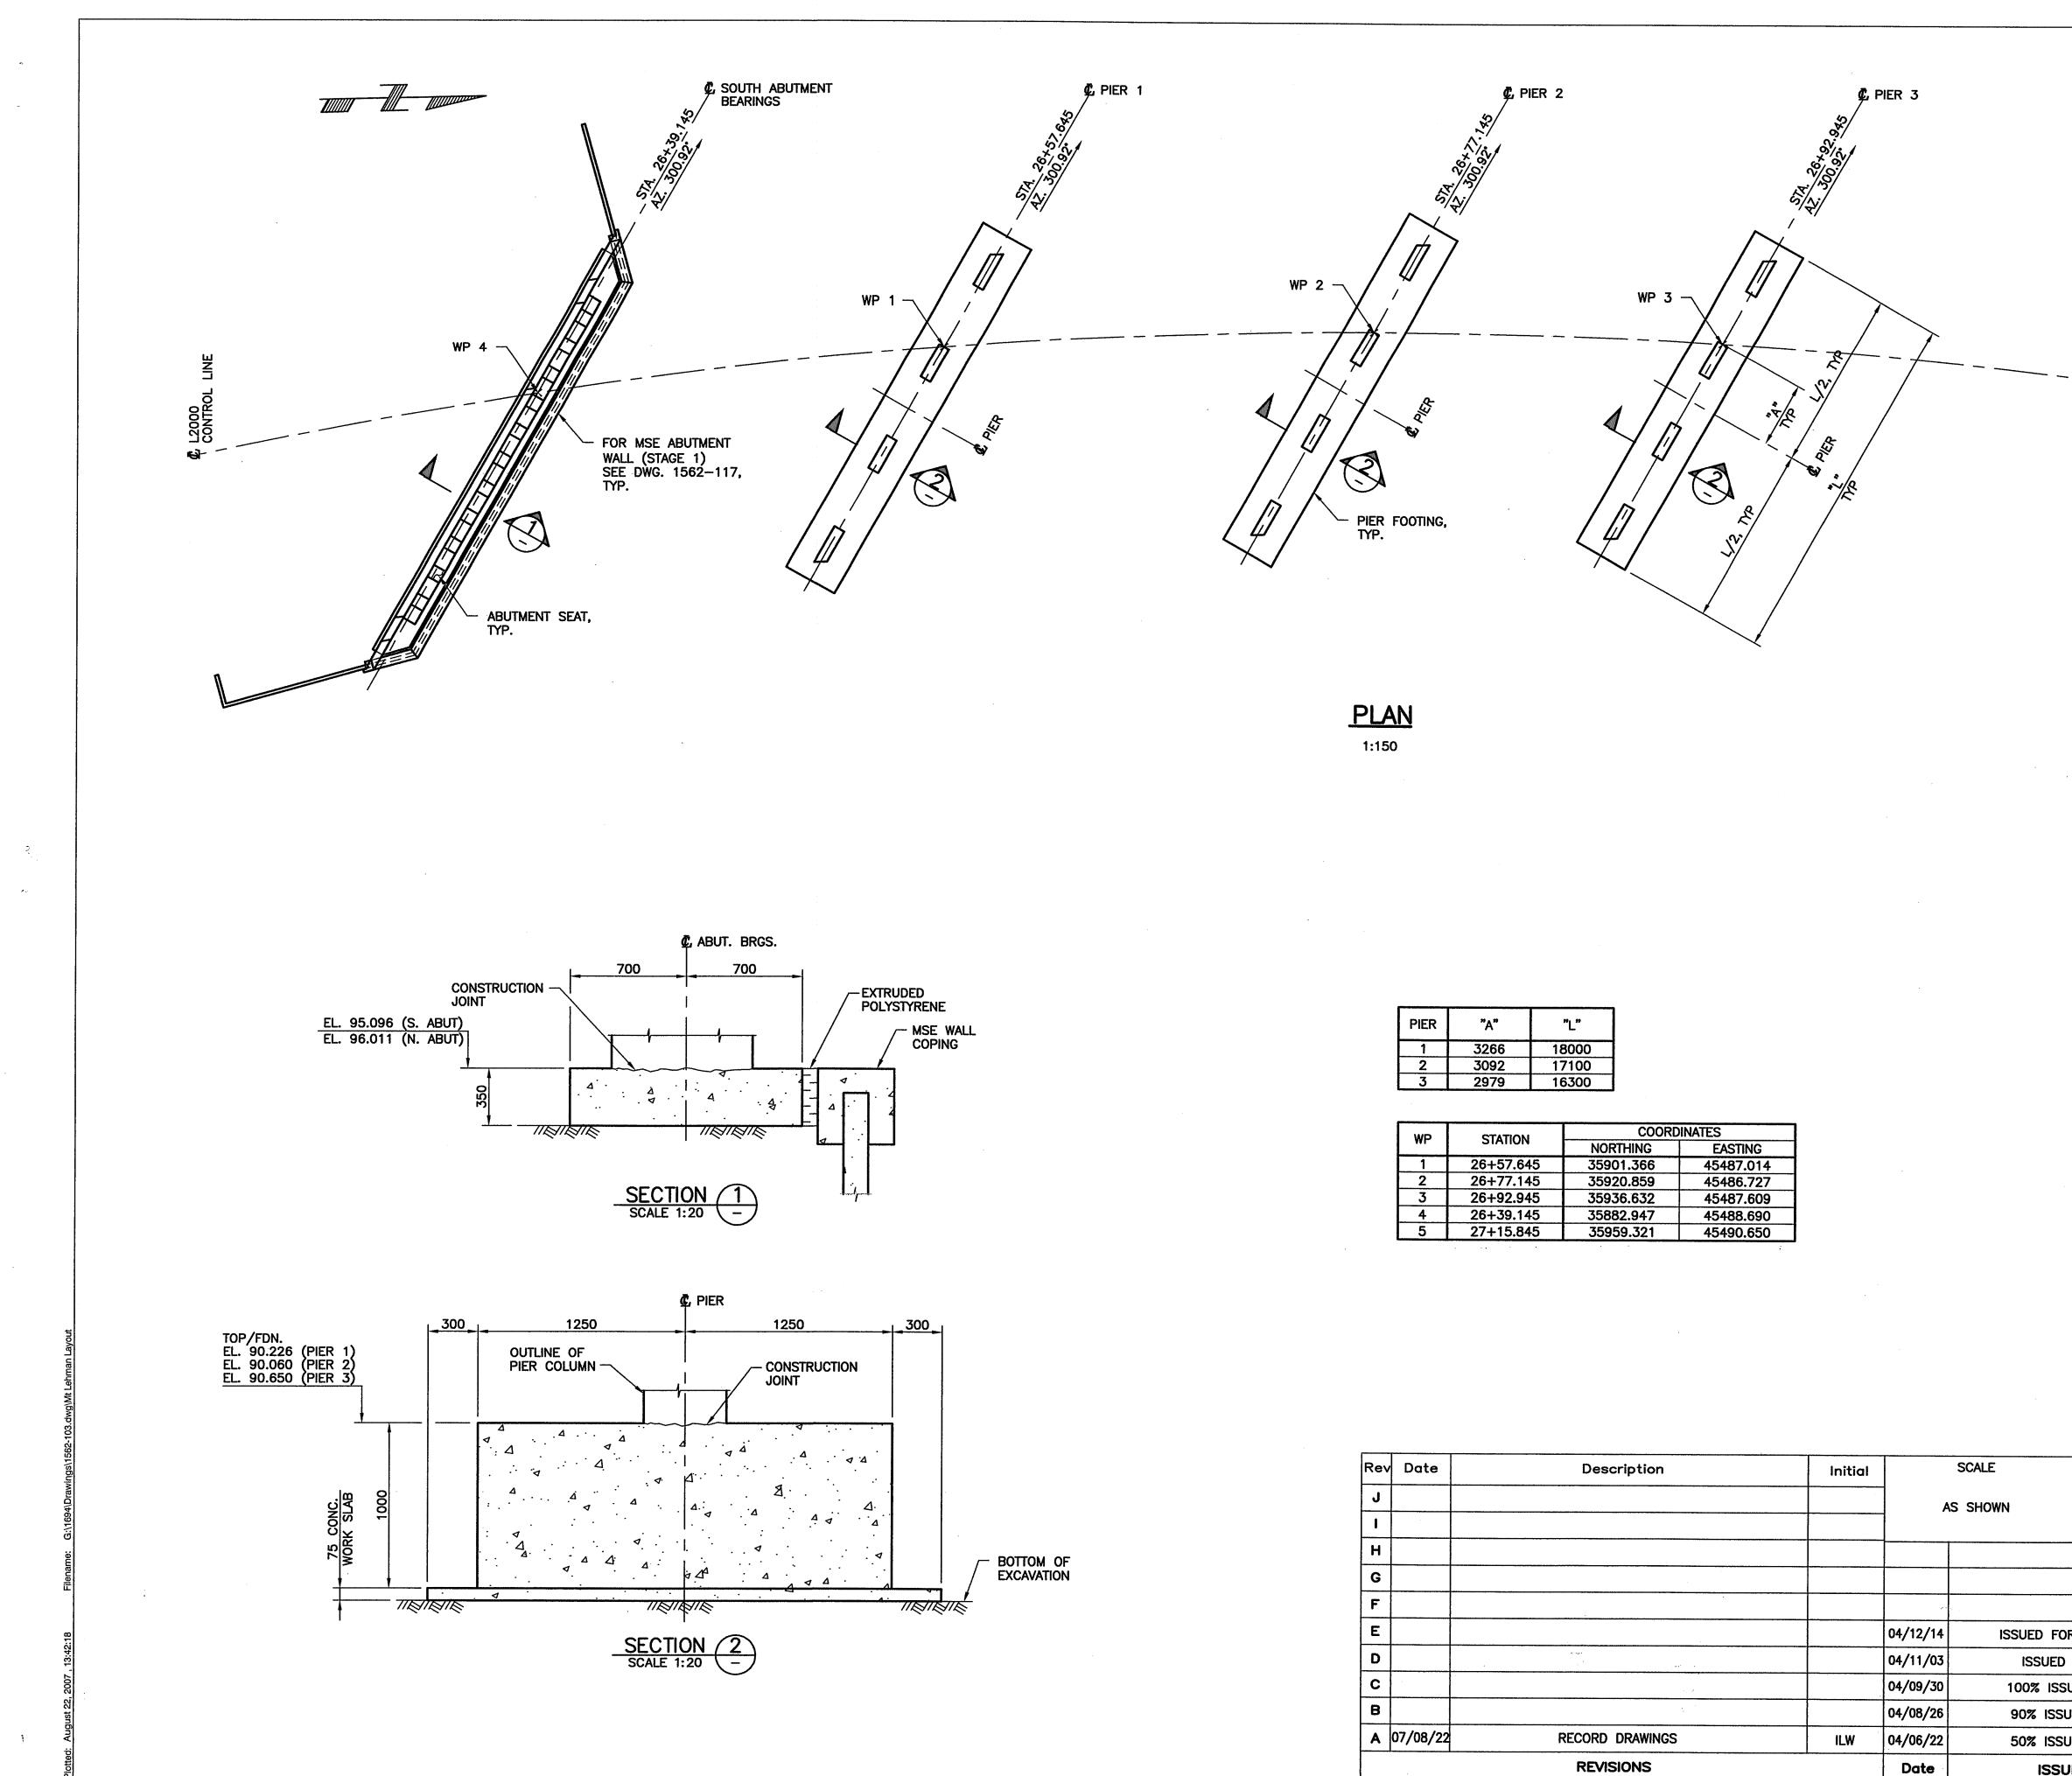
PLAN 1:250

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NCEL PRINTS BEARING EARLIER LETTER

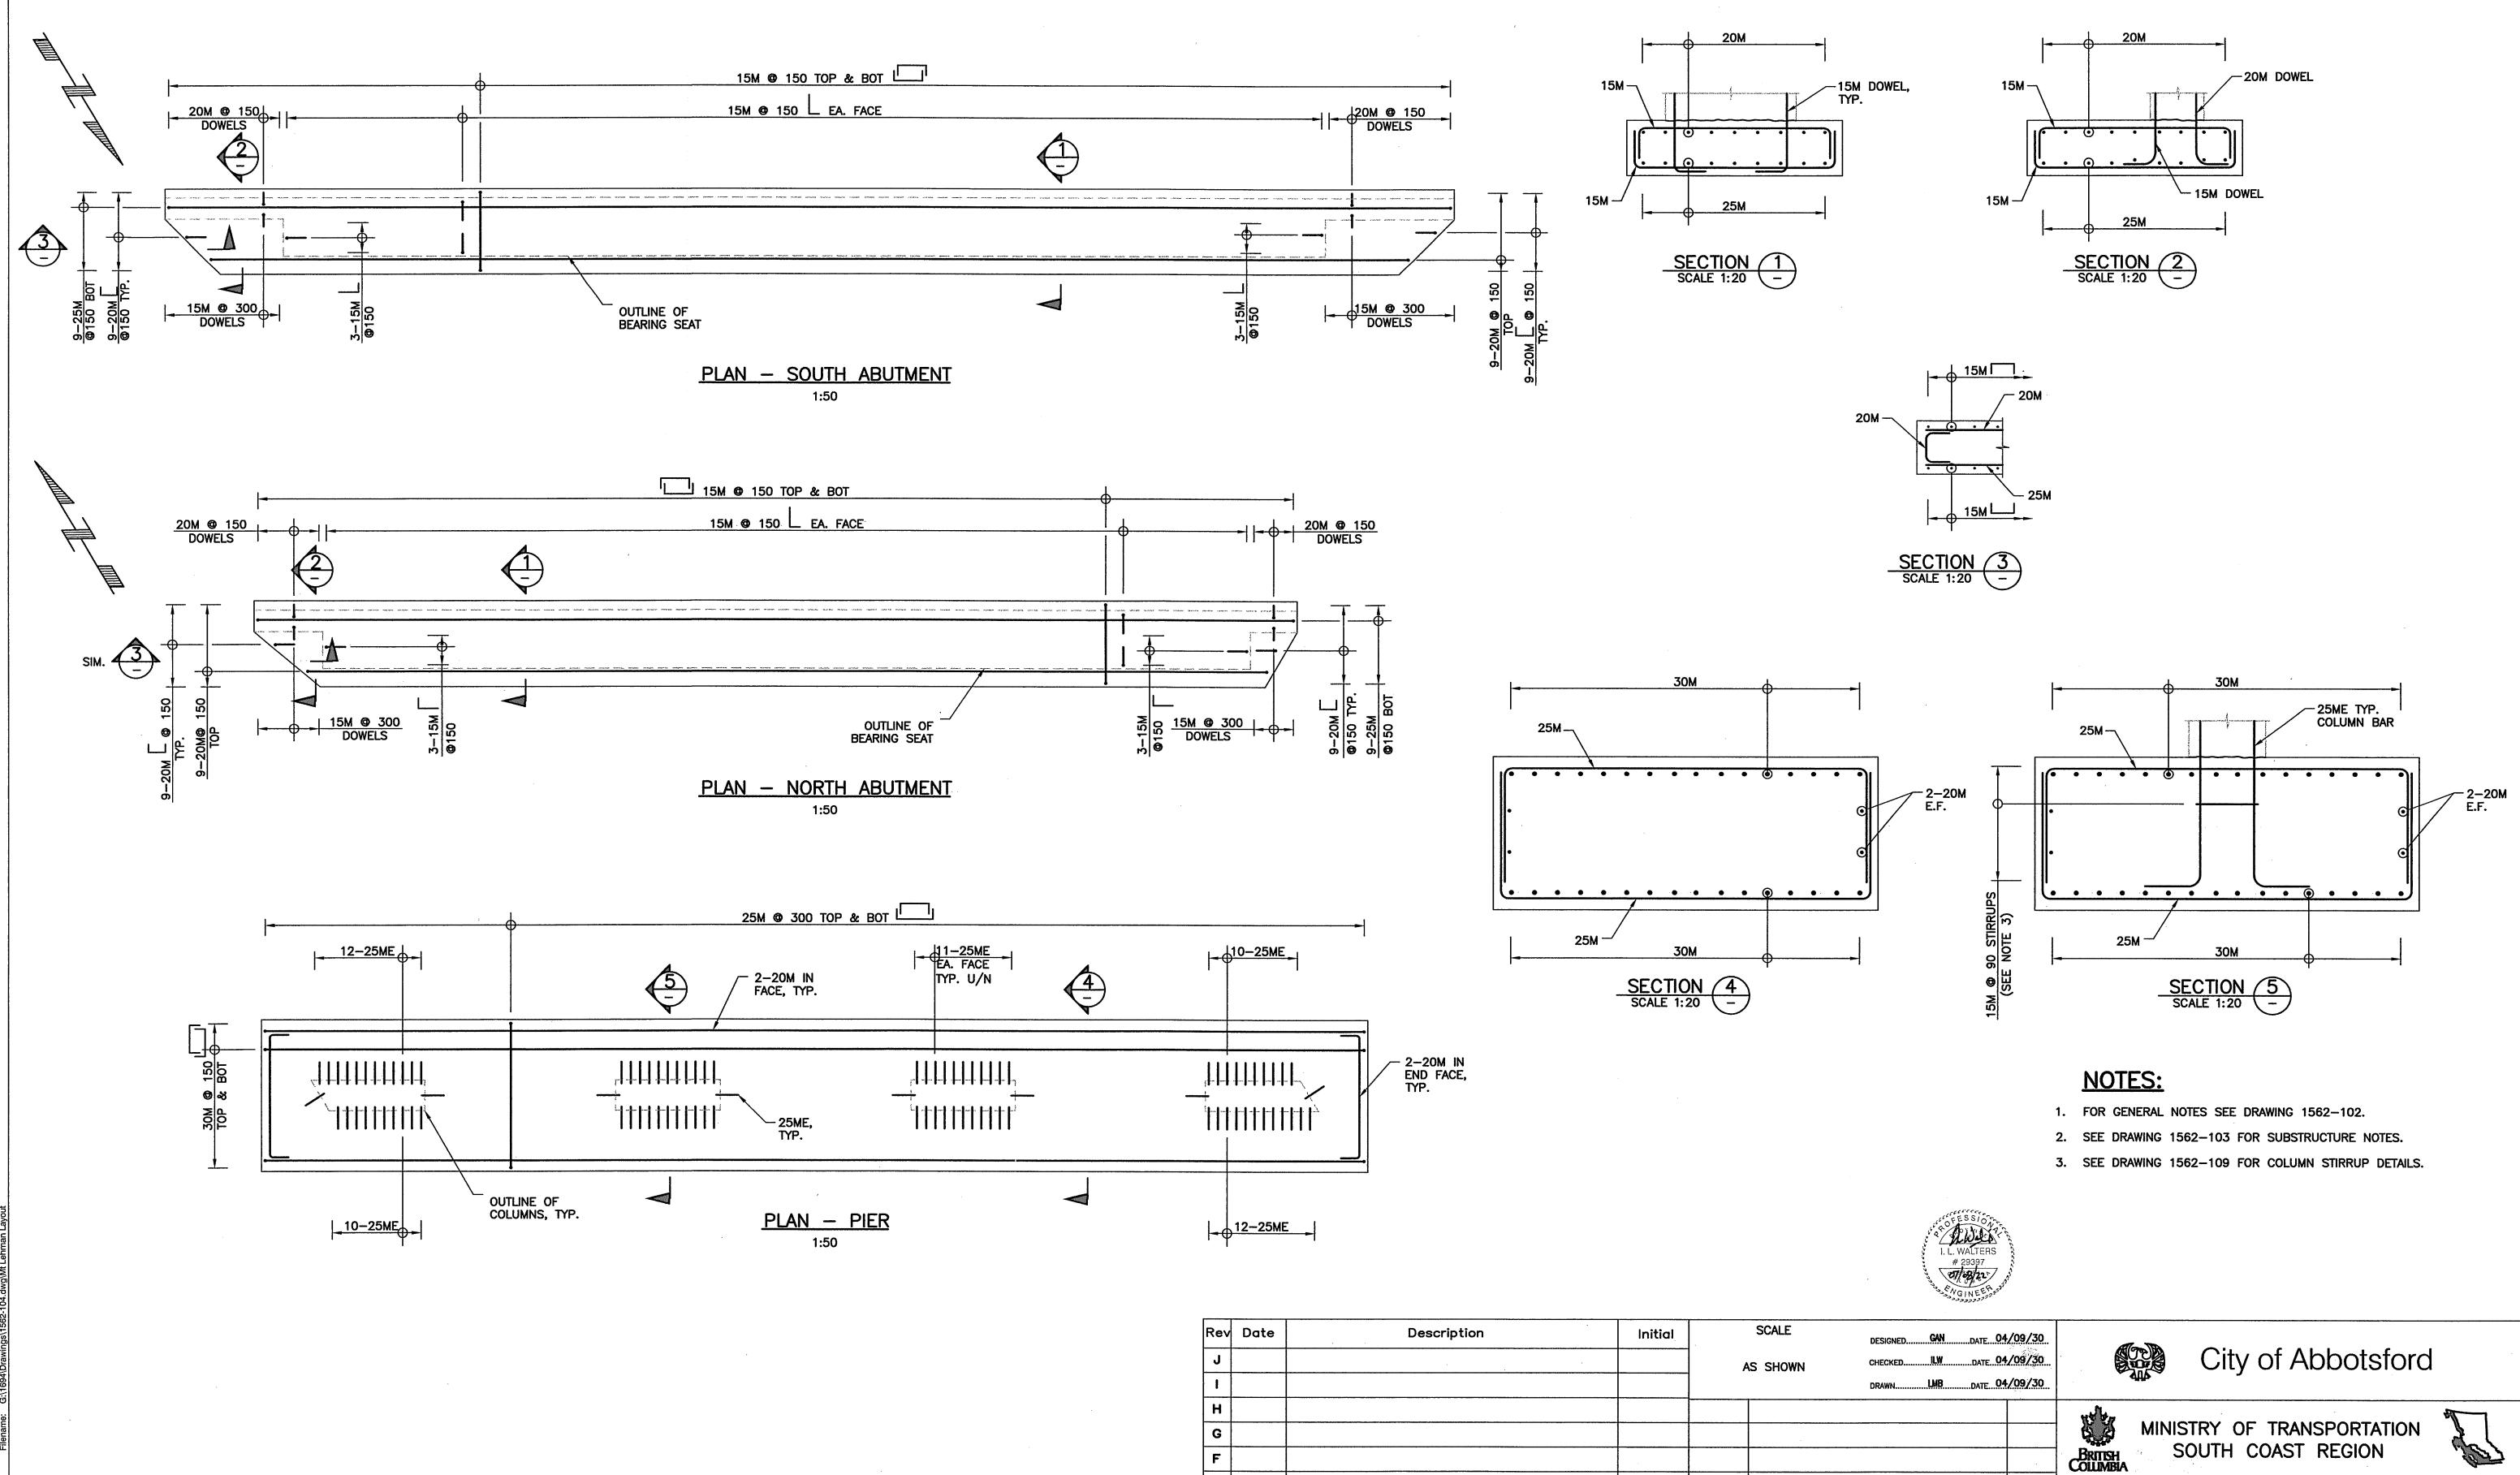


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PIER	" A"	"L"
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2	3092	17100
3	2979	16300

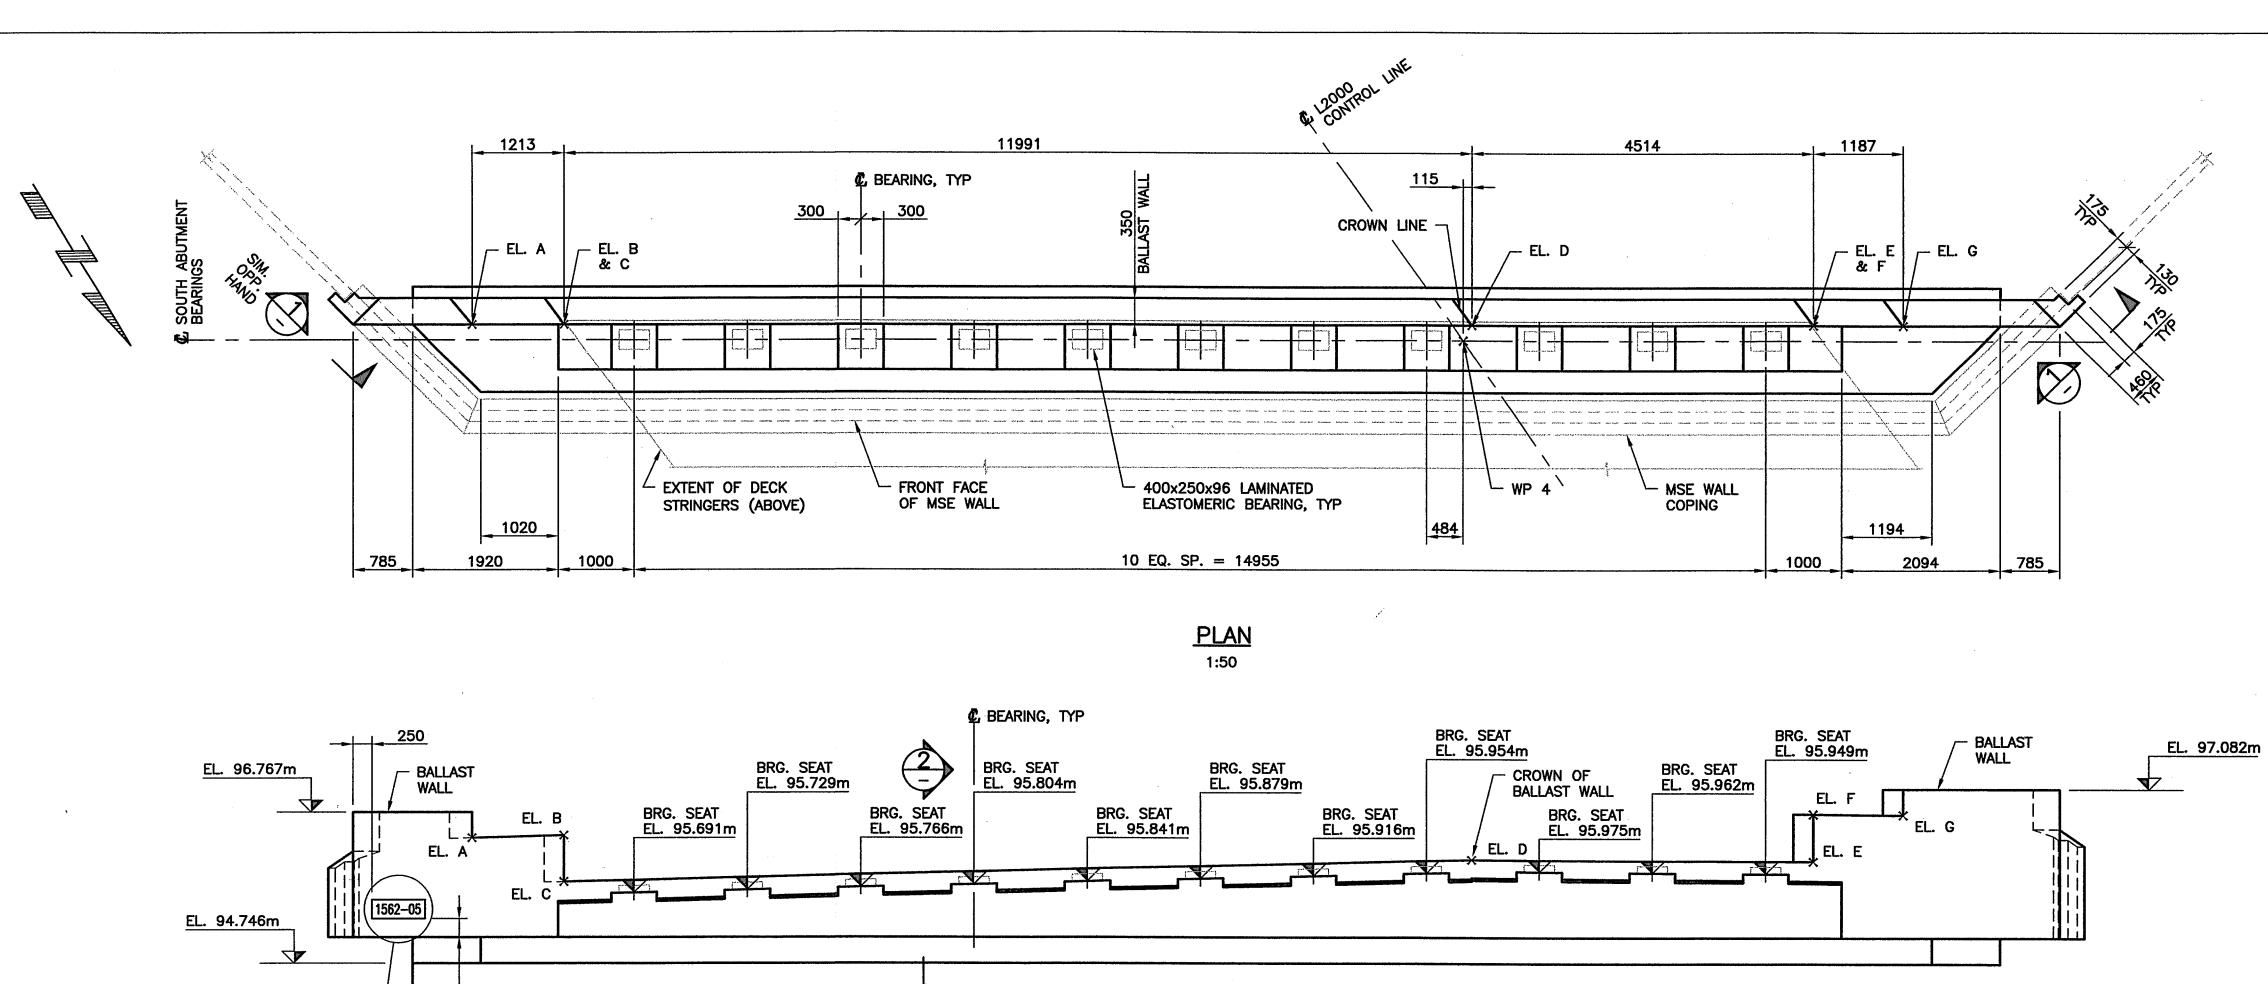
WP	STATION	COORDINATES				
WF	STATION	NORTHING	EASTING			
1	26+57.645	35901.366	45487.014			
2	26+77.145	35920.859	45486.727			
3	26+92.945	35936.632	45487.609			
4	26+39.145	35882.947	45488.690			
5	27+15.845	35959.321	45490.650			

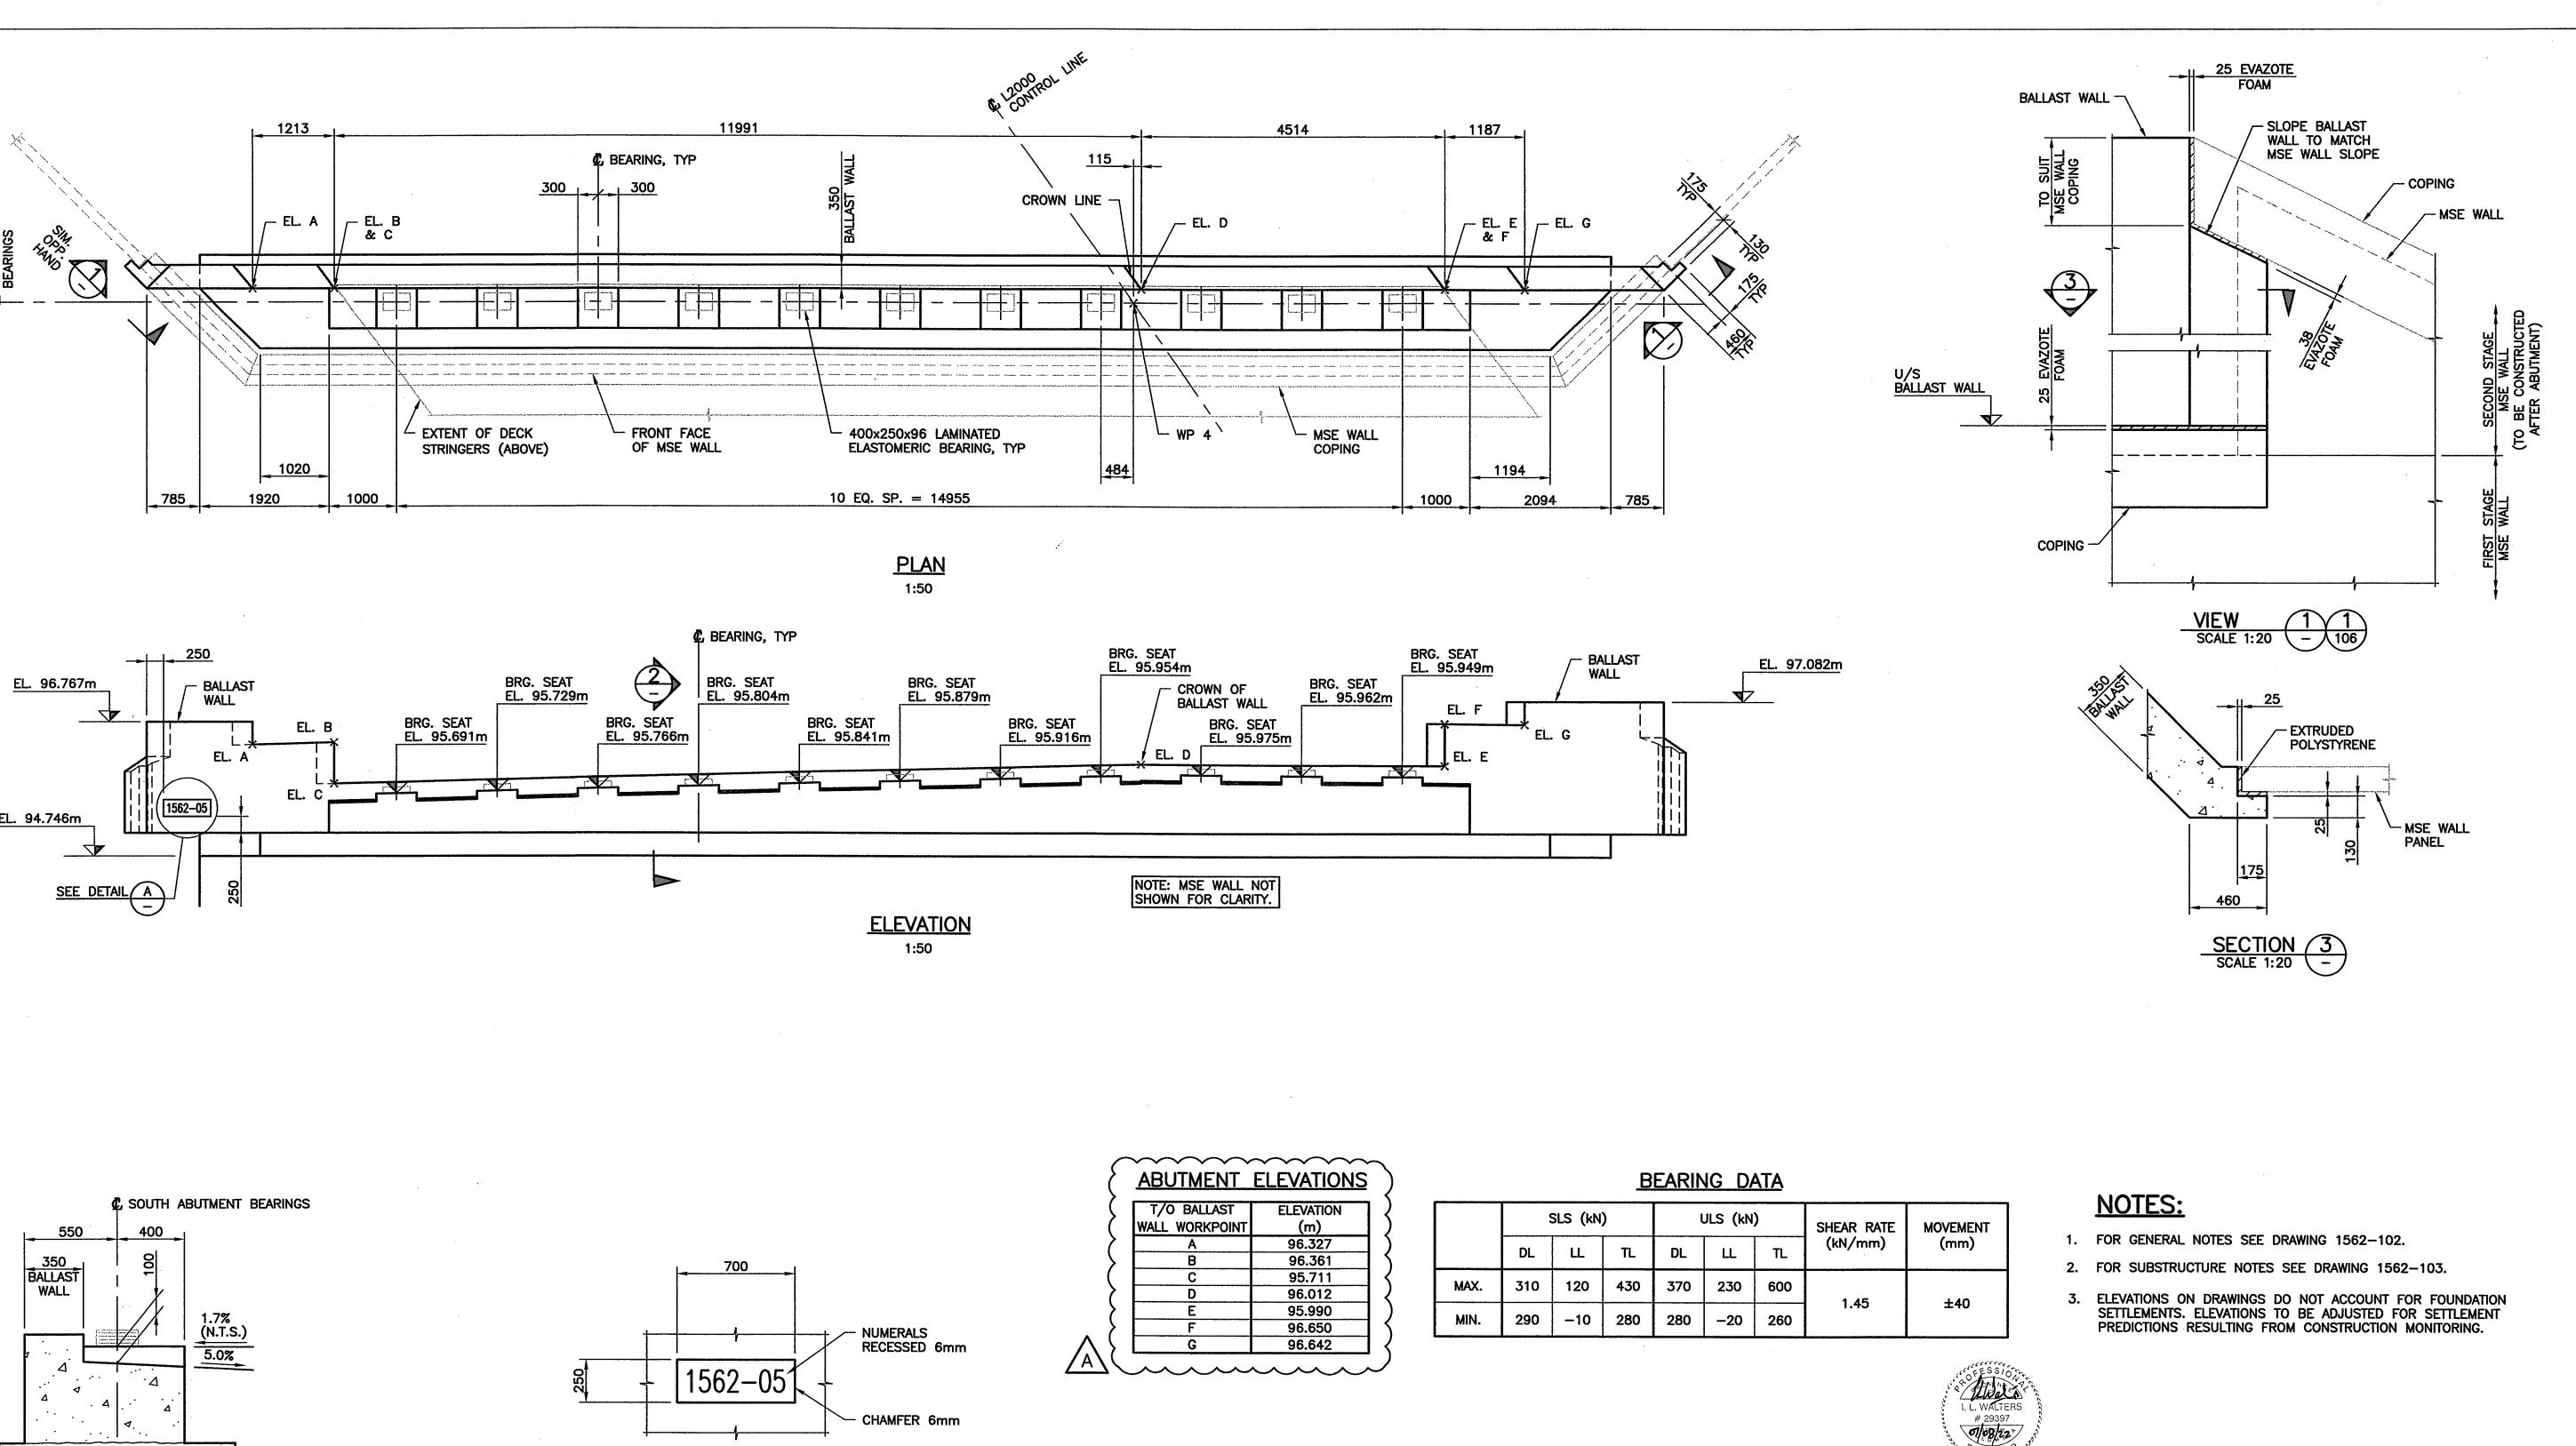
PIER FOOTING, TYP.	PIER 3		SIM. UPPS TANO	P 5
PLAN 1:150			1. 1. 2. 3. 4. 5. 6. 7.	NOTES: FOR GENERAL NOTES SEE DRAWING 1562–102. SUBSTRUCTURE NOTES : CONCRETE SHALL HAVE A MINIMUM COMPRESSIVE STRENGTH AT 28 DAYS AS FOLLOWS: SUBSTRUCTURE CONCRETE: 30 MPg WORK SLAB: 20 MPg ALL EXPOSED EDGES OF CONCRETE SHALL BE CHAMFERED 20mm UNLESS NOTED OTHERWISE. FOOTINGS AND WORK SLABS SHALL BE AT DEPTH SHOWN OR TO LOWER LLEVATIONS AS MAY BE ORDERED BY THE OWNER'S REPRESENTATIVE. ALL REINFORCING STEEL SHALL CONFORM TO CAN/CSA G30.18-M GRADE 400R. MAXIMUM YIELD STRENGTH 525 MPg. CLEAR COVER TO REINFORCING STEEL: CAST AGAINST SOIL: 100mm ELSEWHERE: 70mm BARS DENOTED "ME" SHALL BE EPOXY COATED. ALL LAPS OF REINFORCING BARS FOR SPLICES SHALL BE AS FOLLOWS UNLESS NOTED OTHERWISE: BAR UNDONTED EPOXY EPOXY
2 26+77.145 35920.859 45486.727 3 26+92.945 35936.632 45486.709 4 26+39.145 35882.947 45488.690 5 27+15.845 35959.321 45490.650 5 27+15.845 35959.321 45490.650 1		S SHOWN CHECKED	04/09/30 04/09/30 04/09/30 04/09/30 04/09/30 04/09/30 04/09/30	BAR UNCOATED COATED (B*) COATED (T**) 10M 400 500 600 15M 500 700 850 20M 700 800 1050 25M 1100 1300 1700 30M 1300 1550 2000 (B*) DENOTES VERTICAL BARS WITH LESS THAN 300mm CONCRETE BELOW BARS (T**) DENOTES HORIZONTAL BARS WITH MORE THAN 300mm OF CONCRETE BELOW BARS City of Abbotsford City of Abbotsford MINISTRY OF TRANSPORTATION SOUTH COAST REGION 1562 MT. LEHMAN UNDERPASS FOUNDATION LAYOUT 601898
REVISIONS	Date	50% ISSUE FOR REVIEW	ILW Initial	FILE No. FILE N

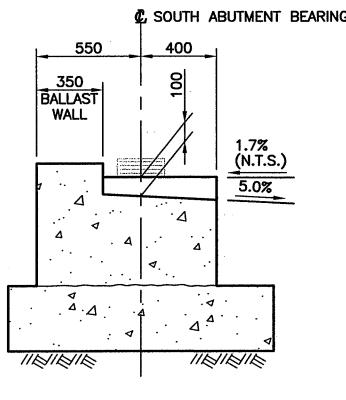


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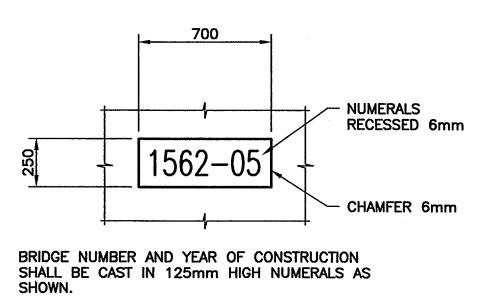
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SECTION 2 SCALE 1:20 -

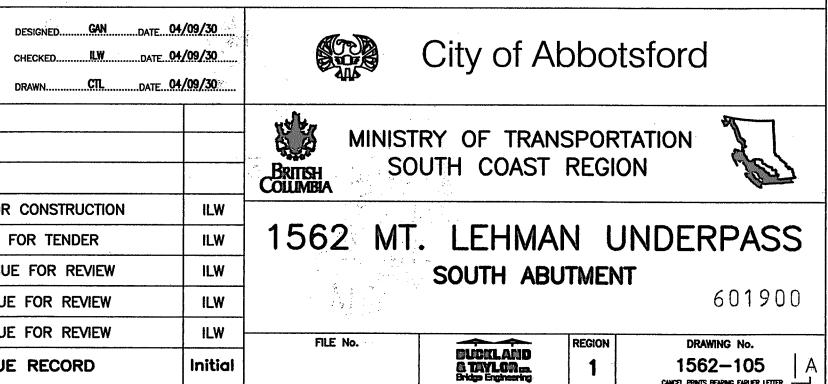


DETAIL SCALE 1:20

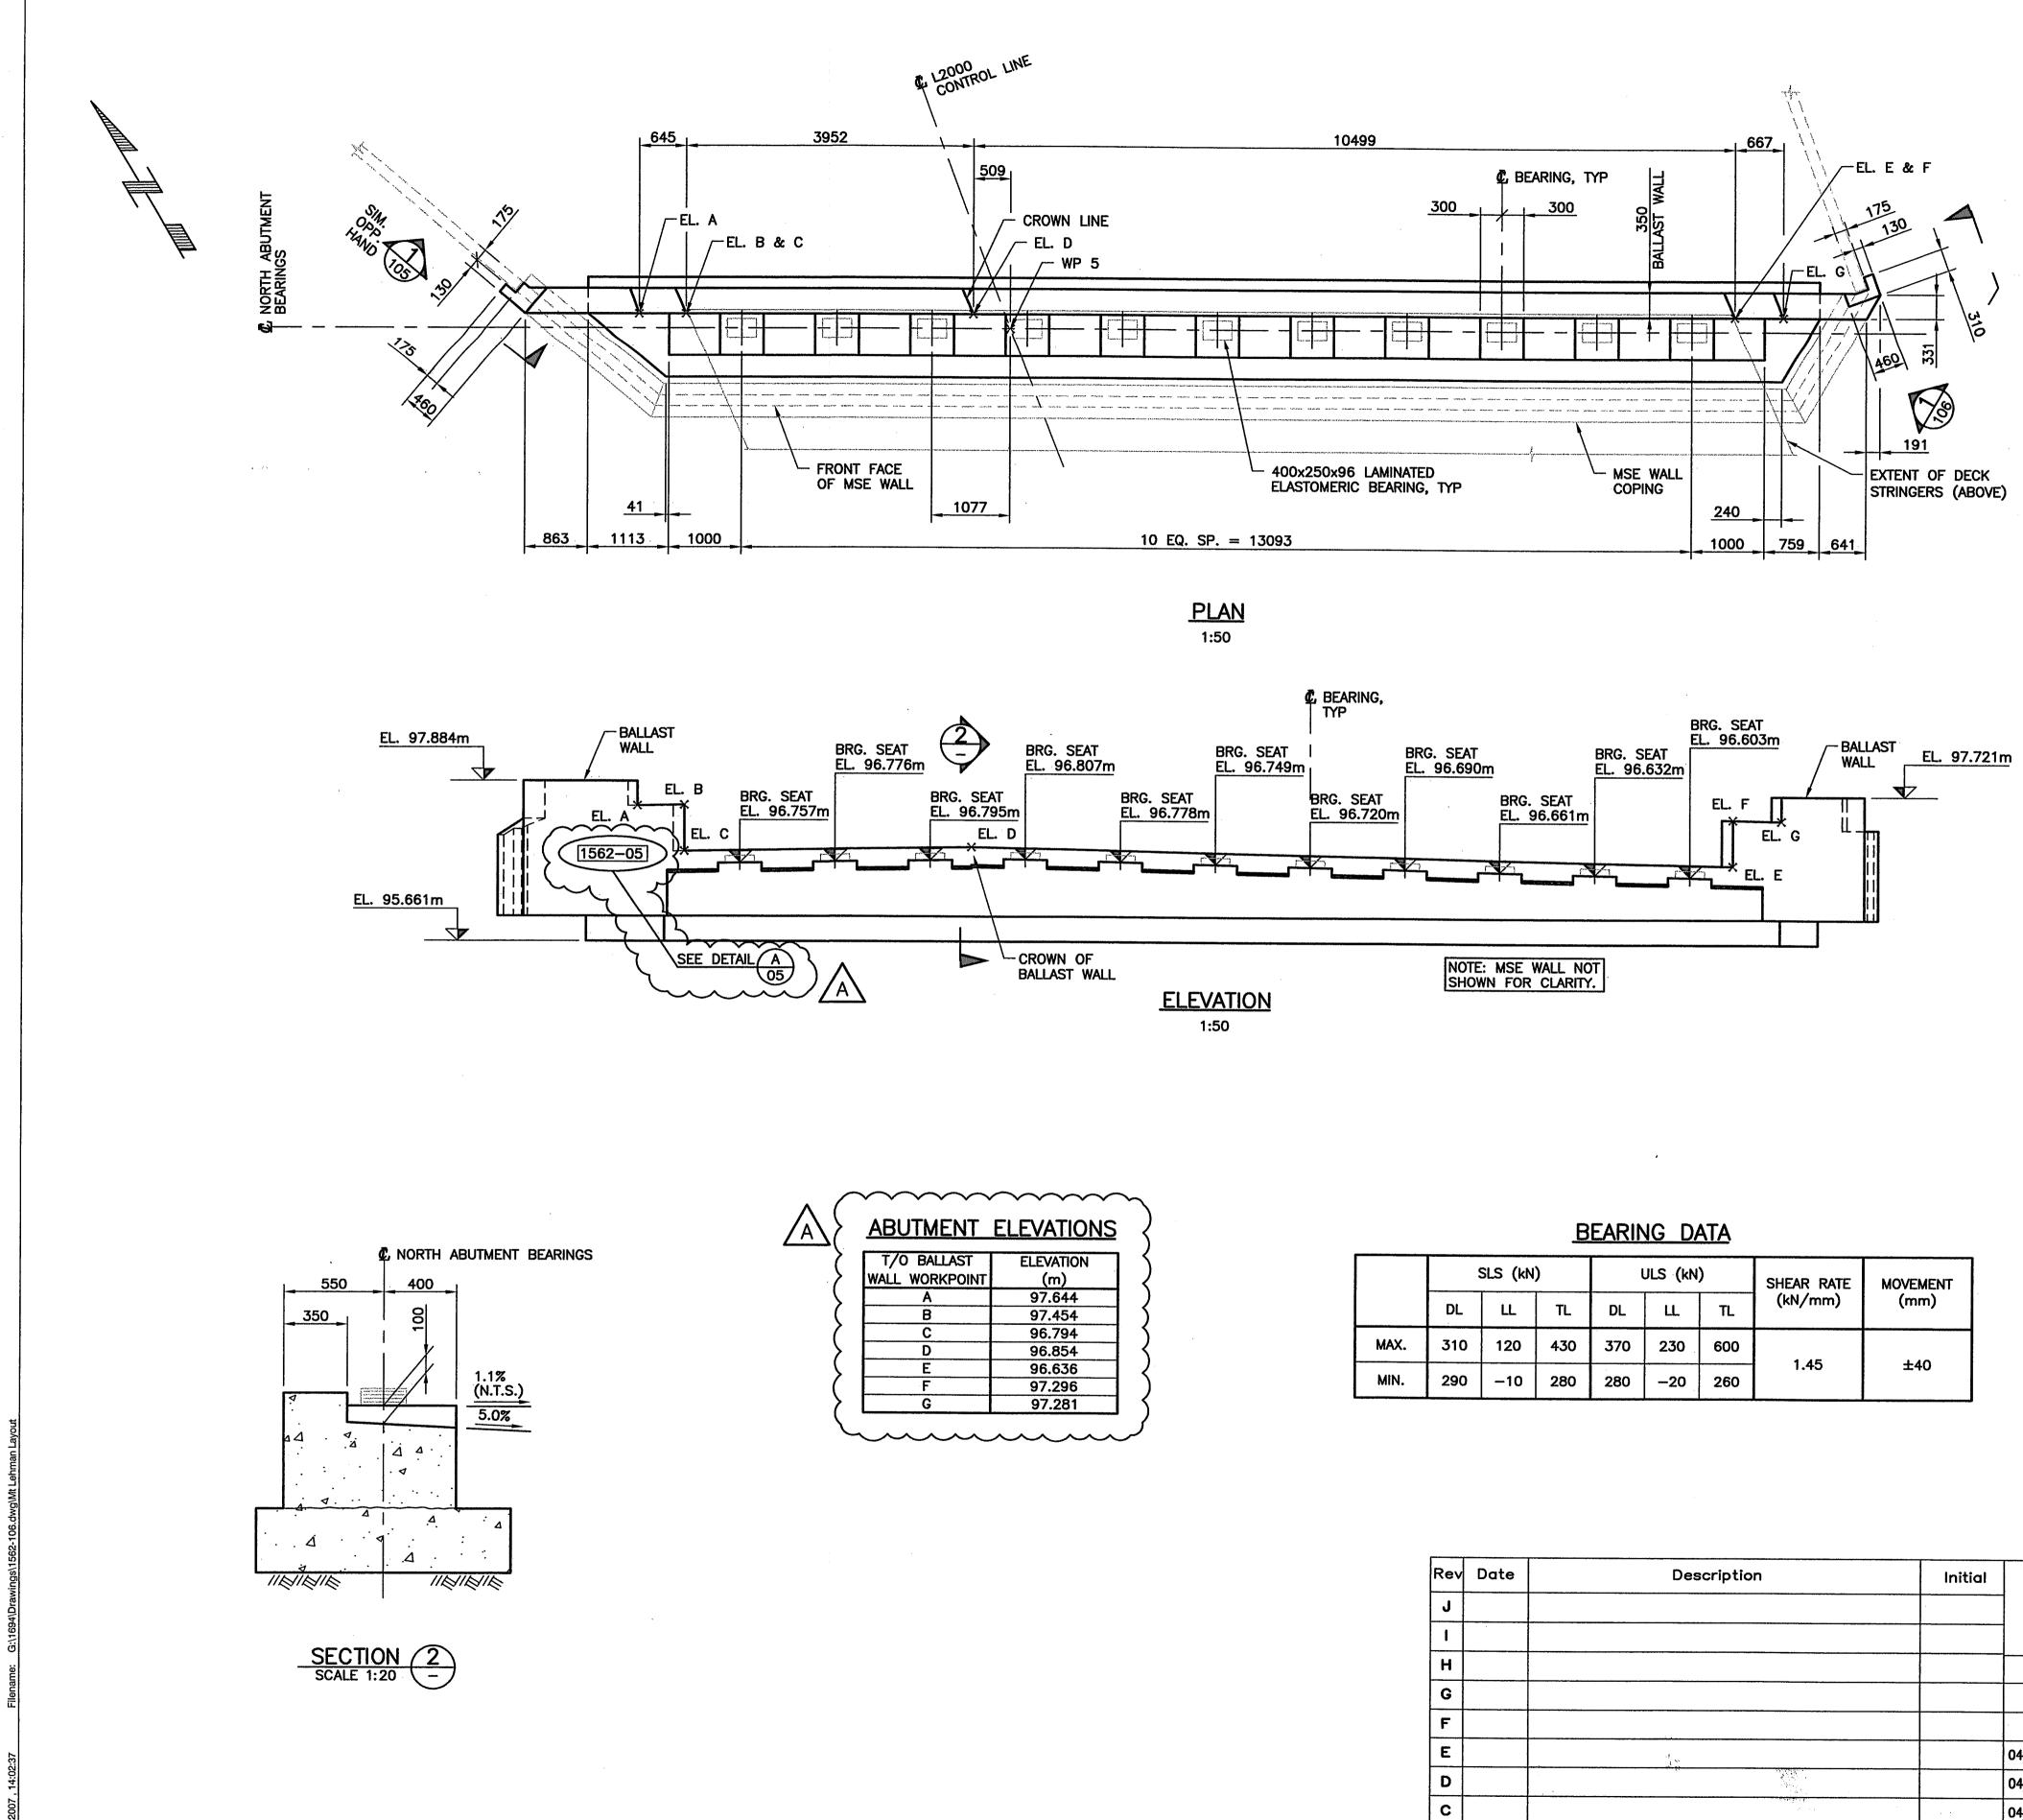
SHEAR)	JLS (kN	L)			
(kN/n	TL	LL	DL	TL	LL	DL	
	600	230	370	430	120	310	MAX.
1.4	260	-20	280	280	-10	290	MIN.

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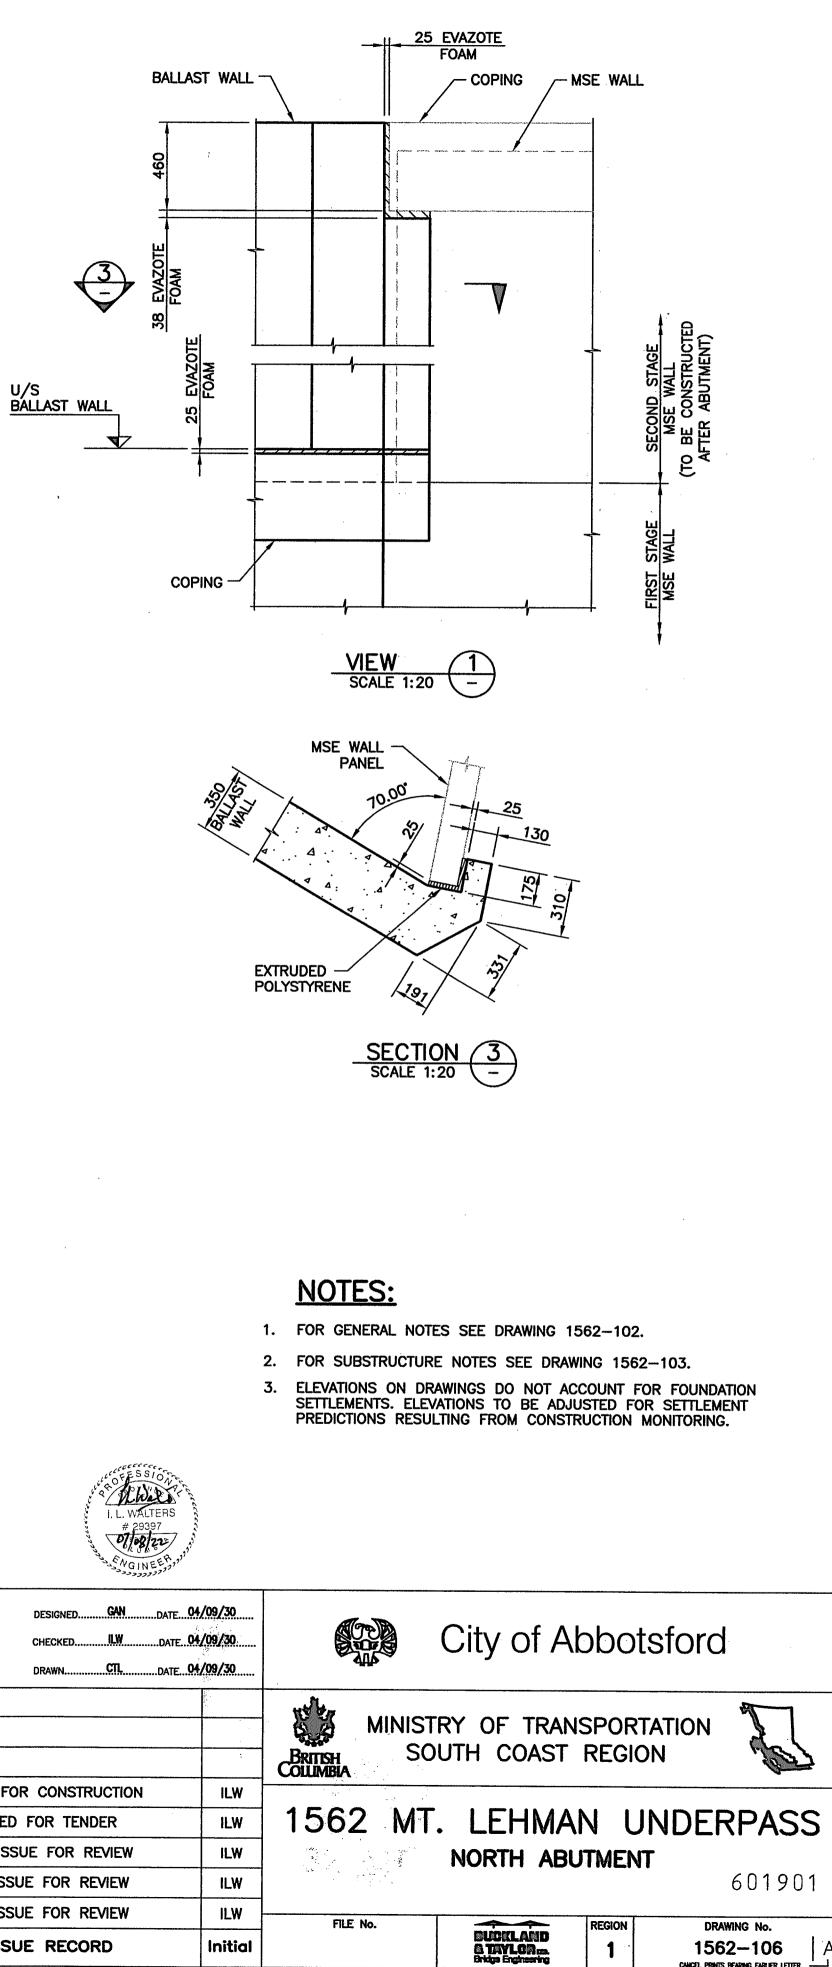


NCEL PRINTS BEARING EARLIER LETTER

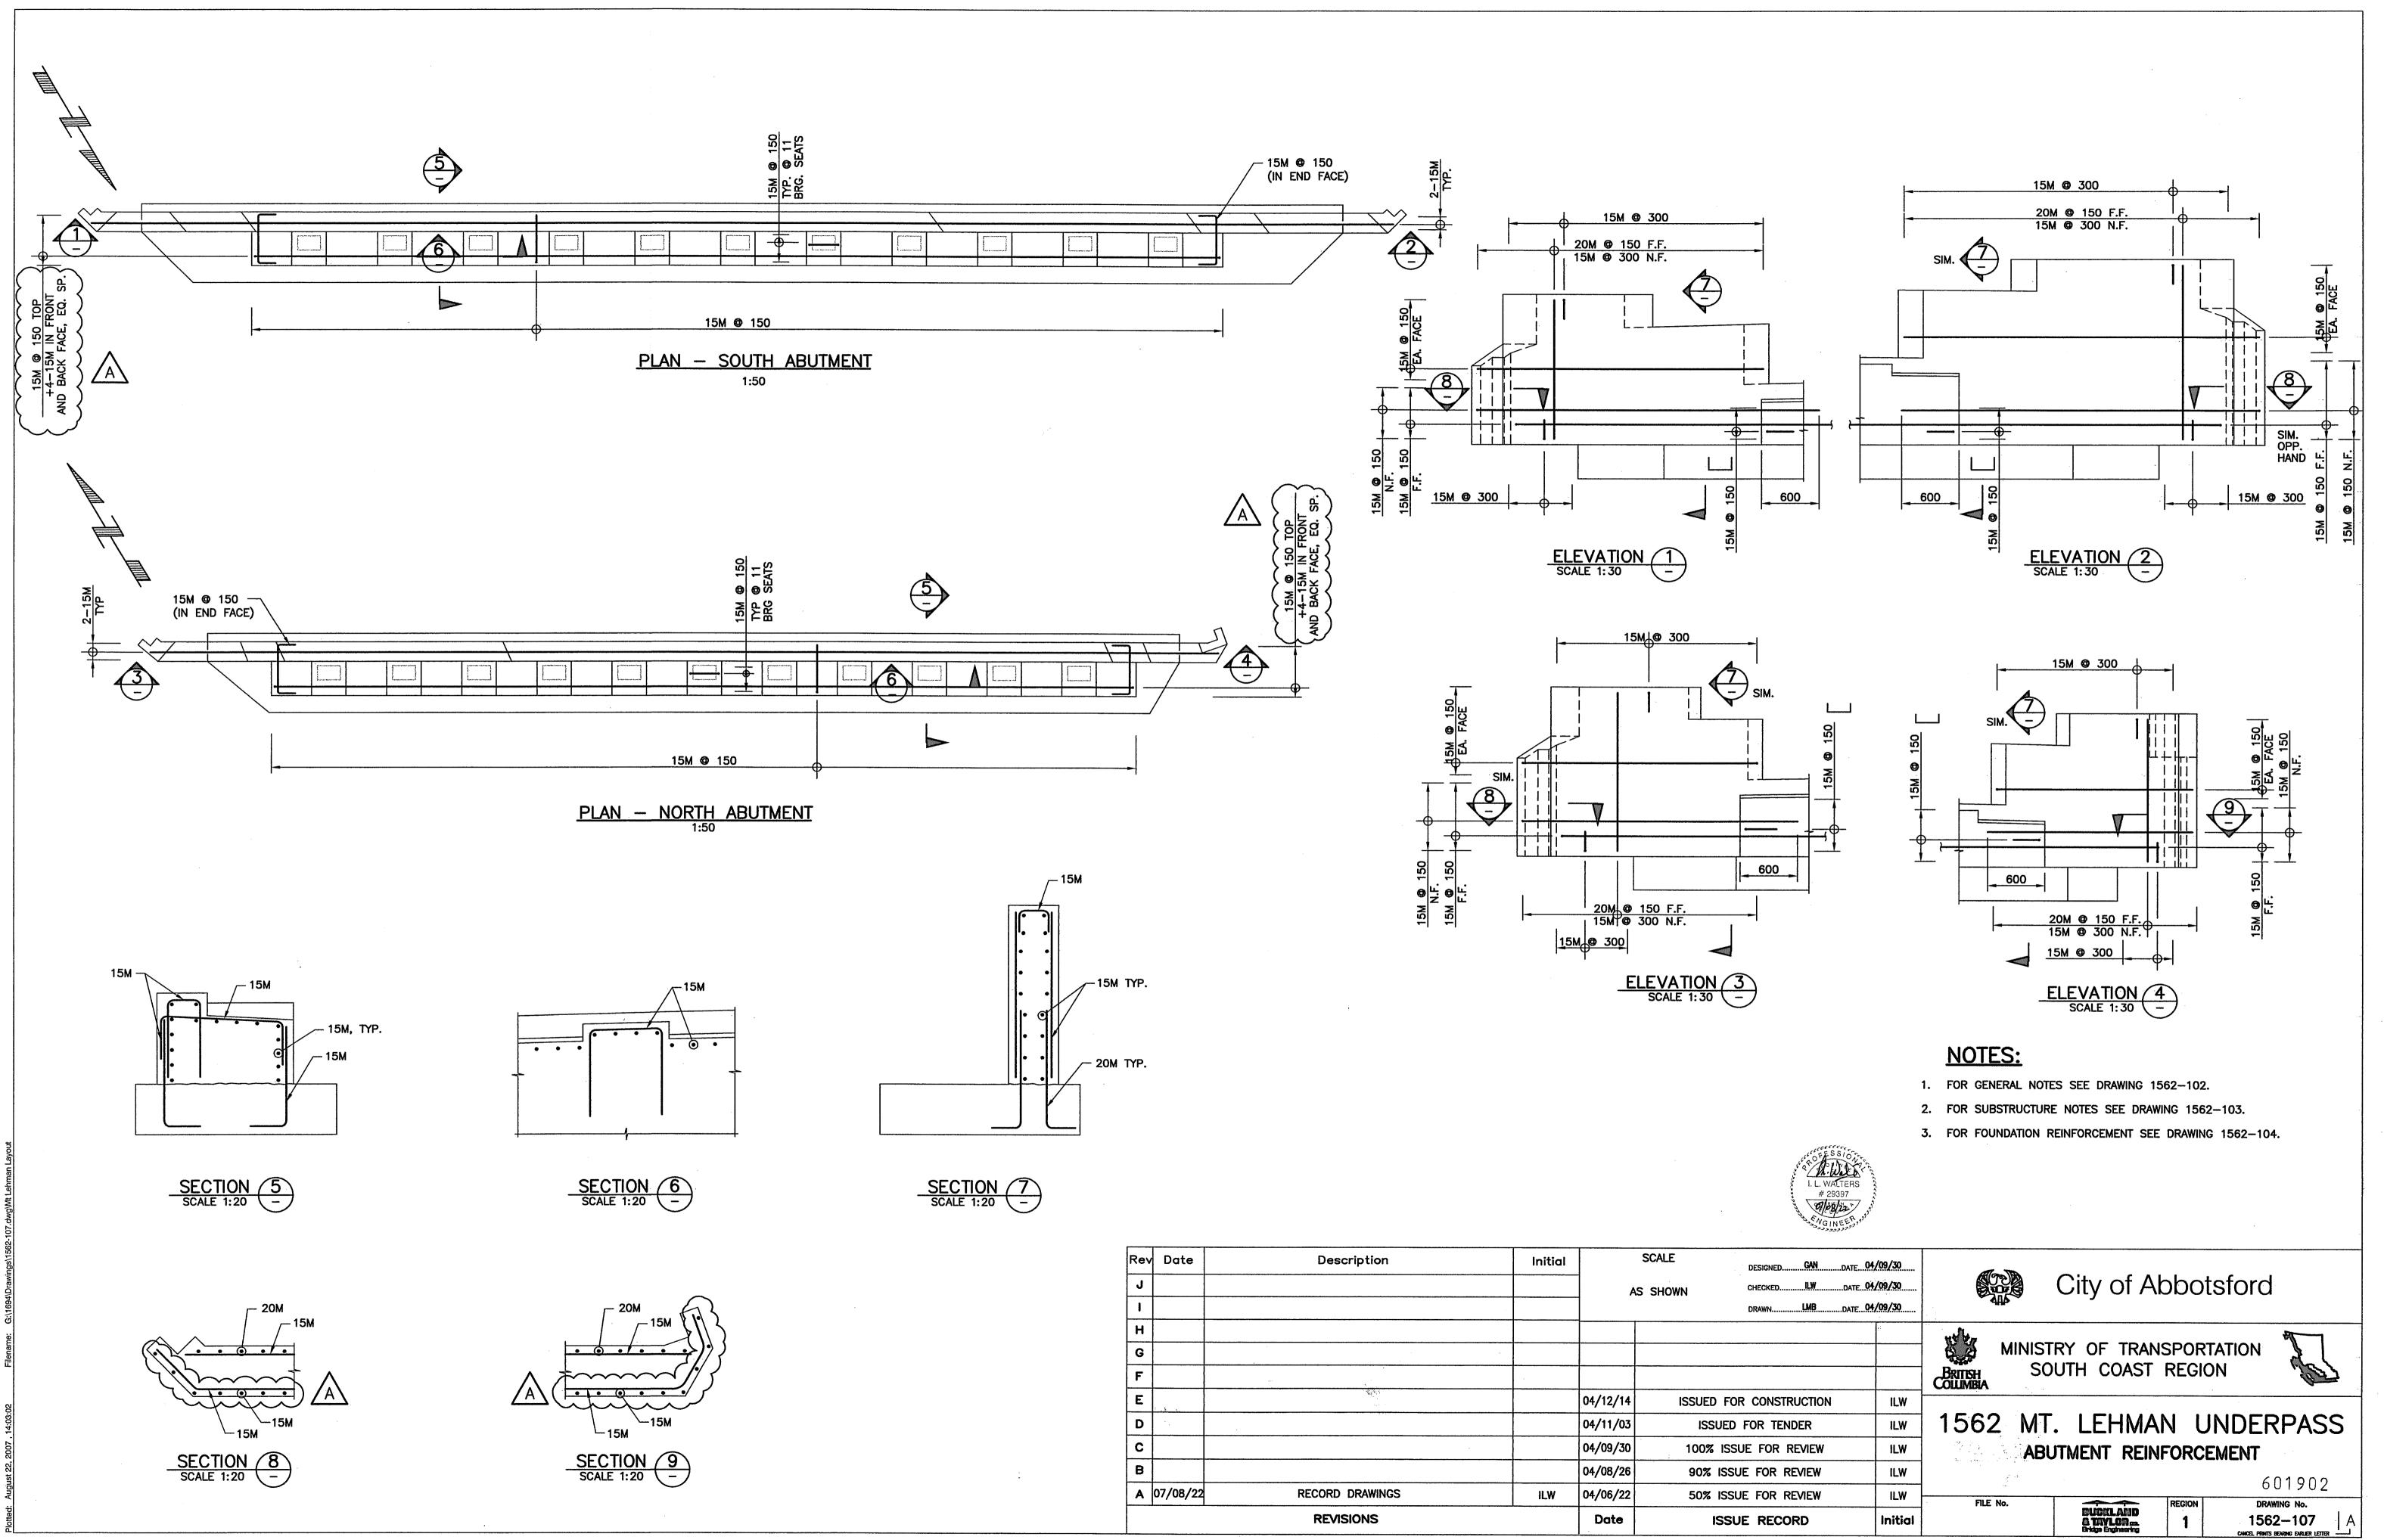


	SLS (kN)			l	JLS (kN)	SHEAR RATE	MOVEMENT	
	DL	LL	TL	DL	LL	TL	(kN/mm)	(mm)	
MAX.	310	120	430	370	230	600	4.45	1.40	
MIN.	290	-10	280	280	-20	260	1.45	±40	

~	07700722	REVISIONS	ILW	04/06/22 Date	50% ISSUE		
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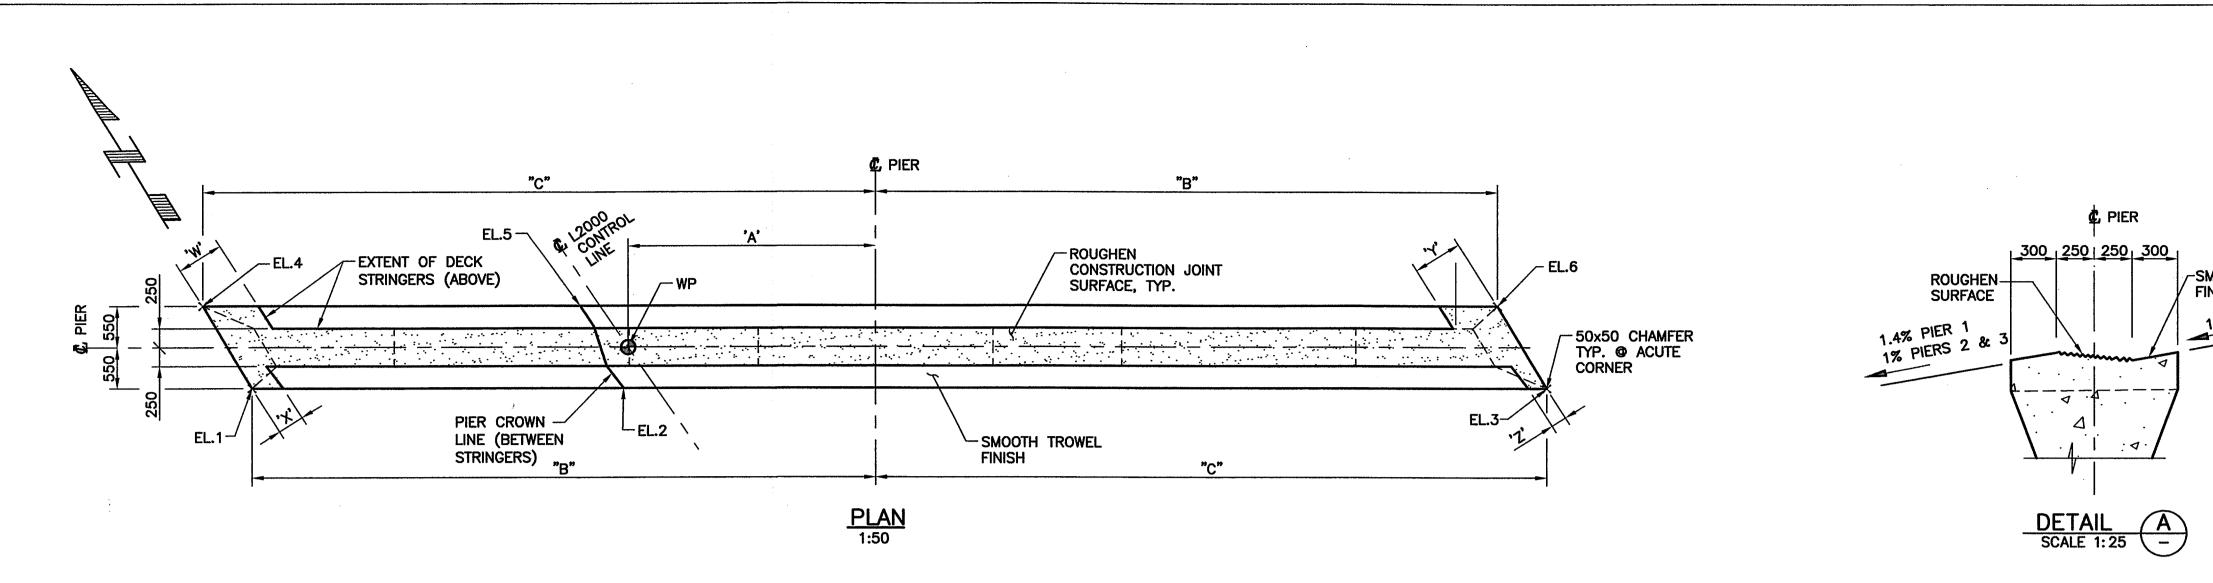
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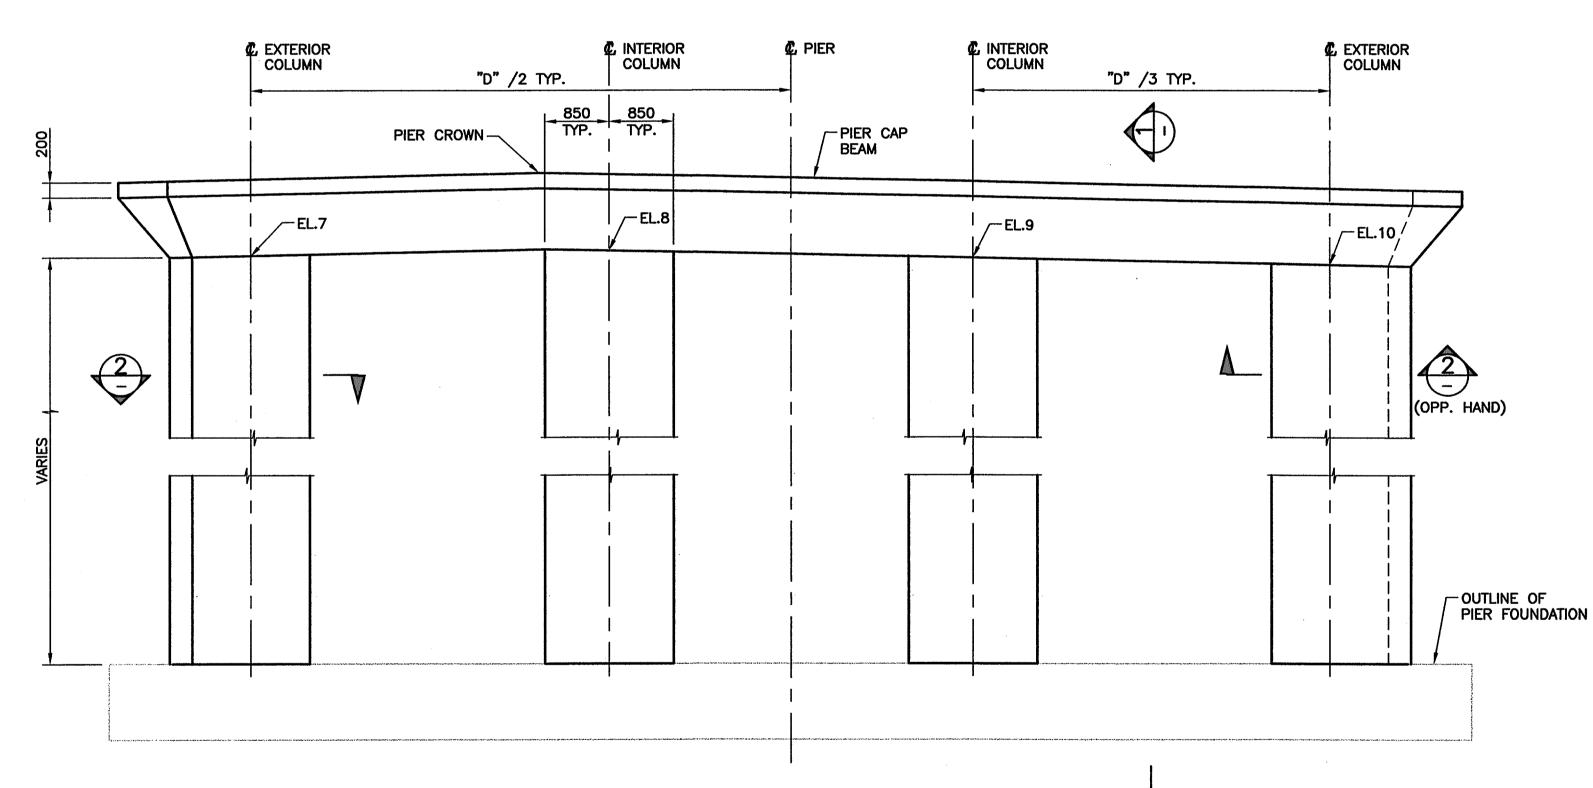


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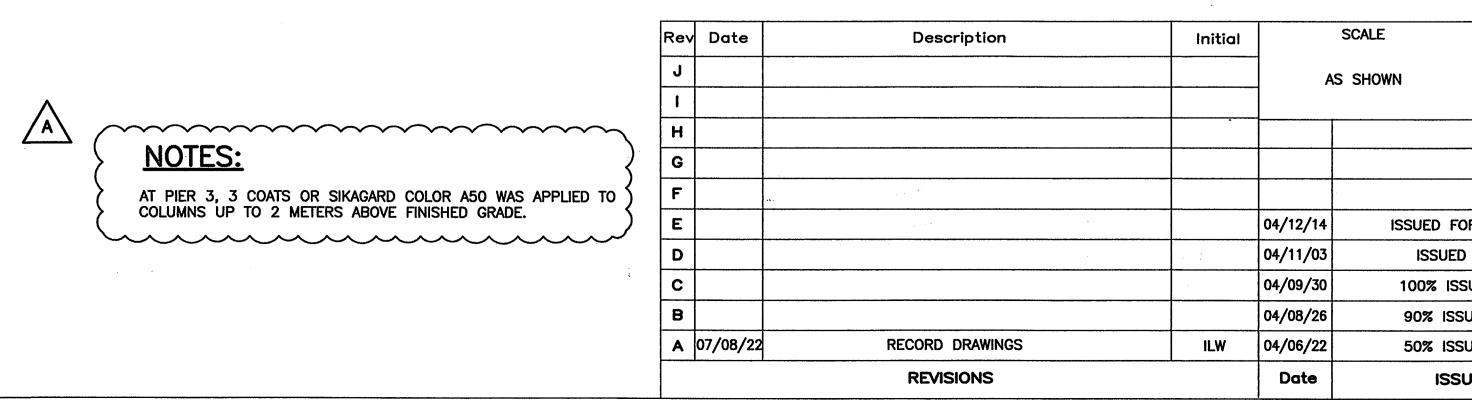
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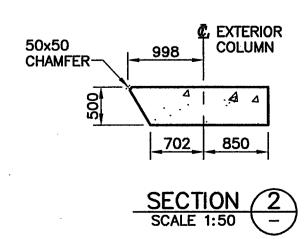
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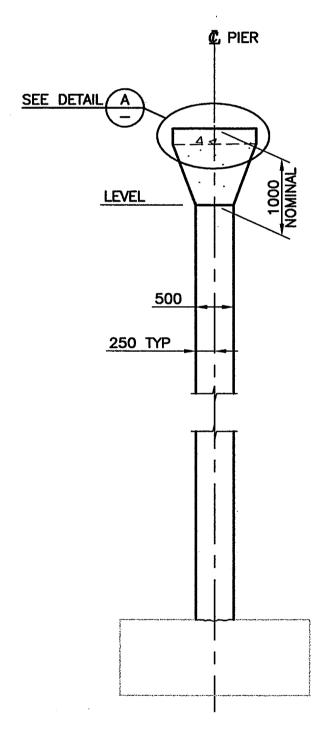


ELEVATION 1:50





2 -



SECTION 1 SCALE 1:50 -

ELEVATIONS					
PIER	NO.	ELEVATION (m)			
	1	96.206			
	2	96.247			
	3	95.940			
1	4	96.200			
1	5	96.258			
	6	95.982			
	7	95.216			
	8	95.232			
	9	95.113			
	10	94.994			
	1	96.388			
	2	96.443			
	3	96.177			
2	4	96.391			
2	5	96.454			
	6	96.198			
	7	95.406			
	8	95.429			
1	9	95.324			
	10	95.219			
	1	96.544			
	2	96.600			
	3	96.347			
7	4	96.546			
3	5	96.613			
	6	96.367			
	7	95.562			
	8	95.588			
	9	95.488			
	10	95.388			

PIER GEOMETRY

PIER	"A"	"В"	"C"	"D"
1	3266	8225	8875	14400
2	3092	7785	8435	13520
3	2979	7450	8100	12850
r				
PIER	"W"	"X"	"Y"	'Z'
1	631	355	668	210
2	572	289	518	252
3	570	229	424	283

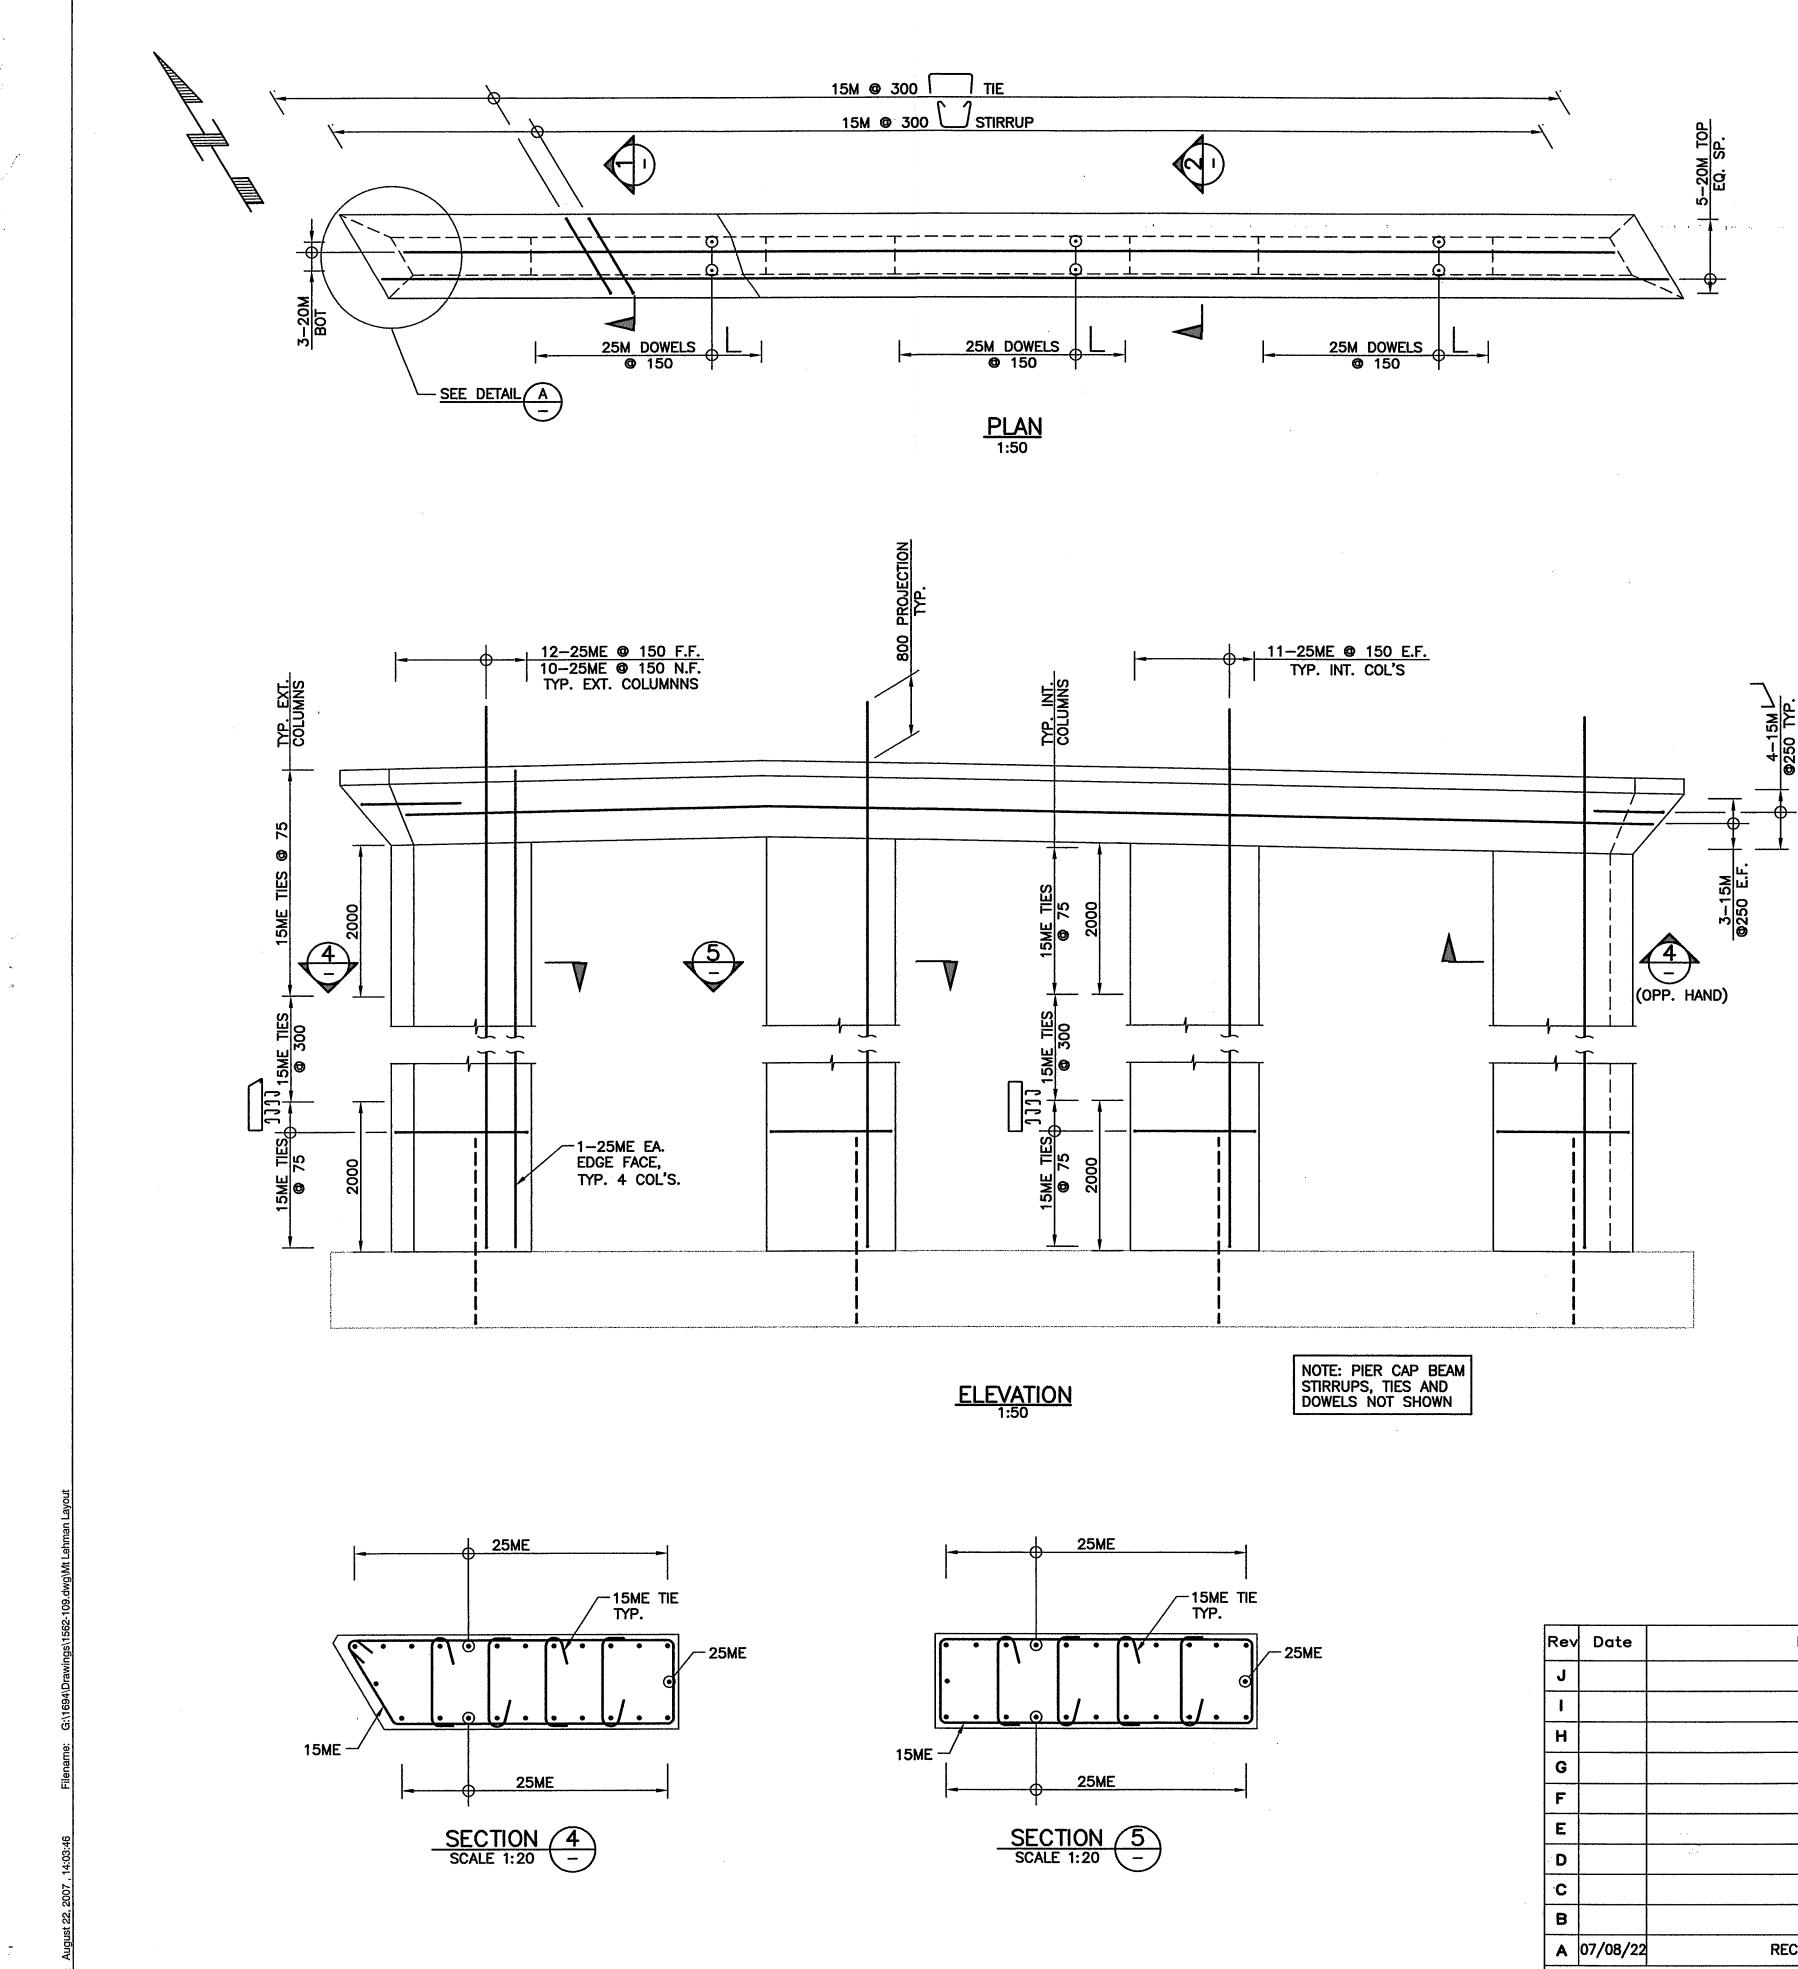
NOTES:

- 1. FOR GENERAL NOTES SEE DRAWING 1562-102.
- 2. SEE DRAWING 1562-103 FOR SUBSTRUCTURE NOTES.
- 3. ELEVATIONS ARE BASED ON 75mm THICK TEMPORARY SUPPORTS FOR DECK STRINGERS.
- 4. ELEVATIONS ON DRAWINGS DO NOT ACCOUNT FOR FOUNDATION SETTLEMENTS. ELEVATIONS TO BE ADJUSTED FOR SETTLEMENT PREDICTIONS RESULTING FROM CONSTRUCTION MONITORING.

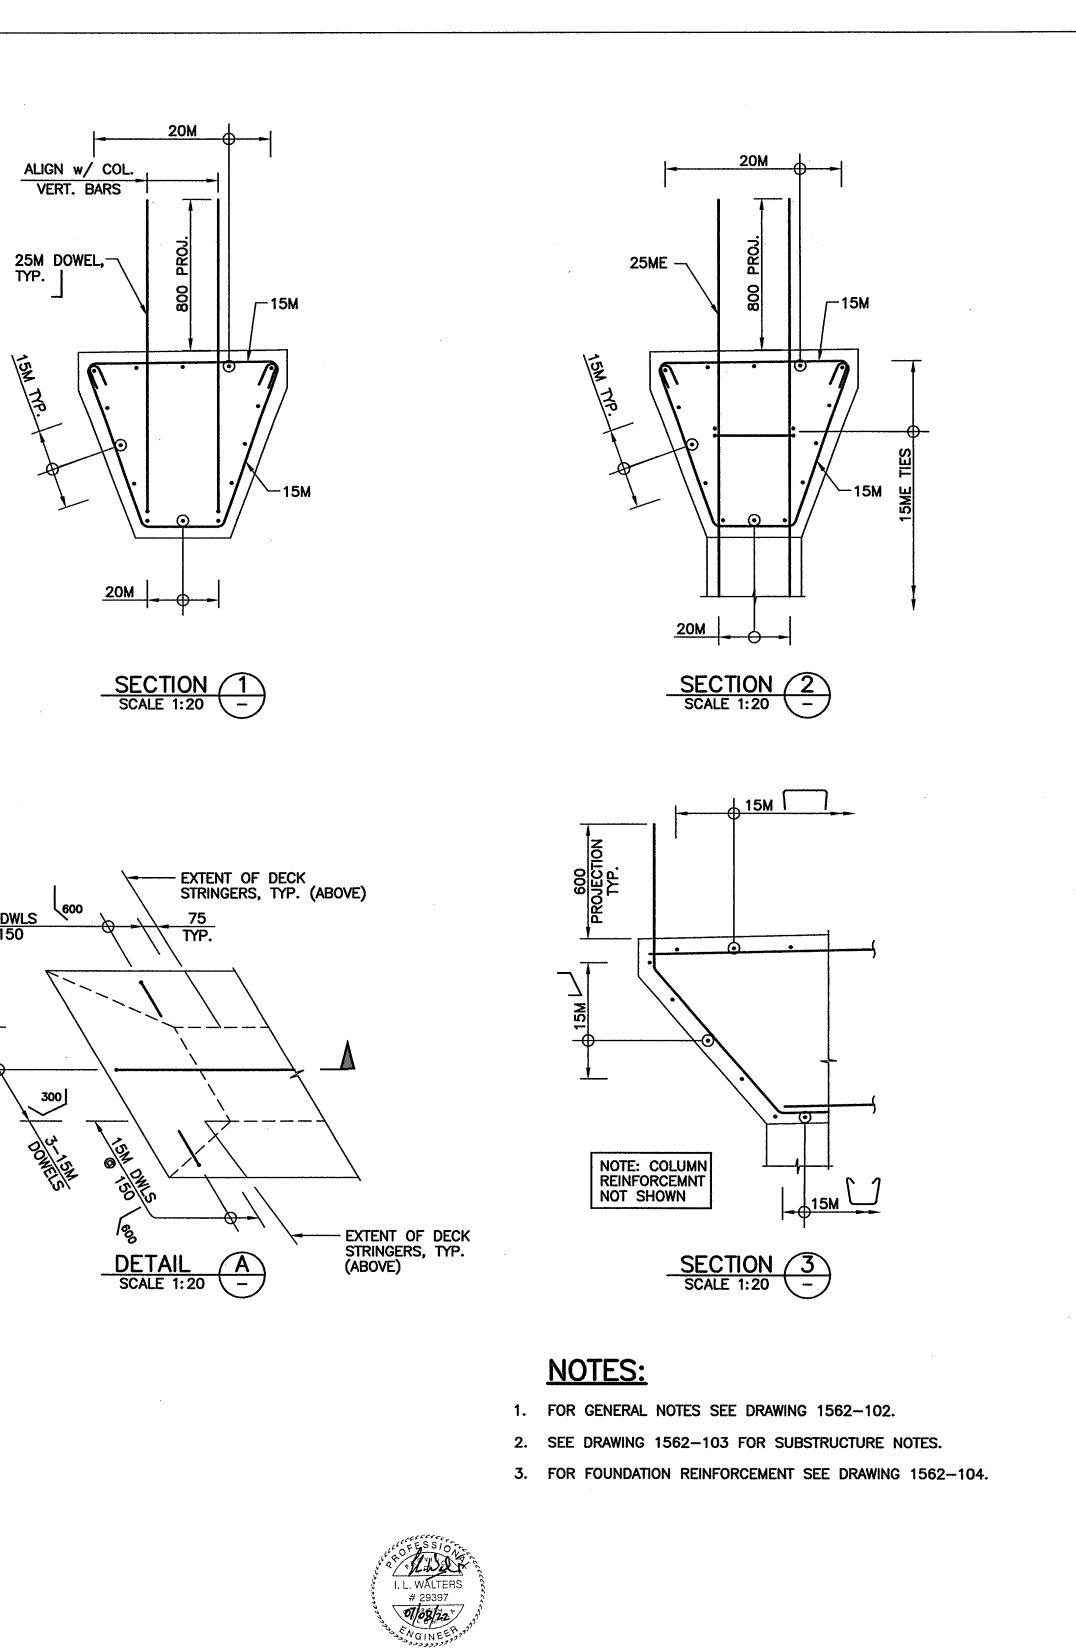
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		MINISTRY OF TRANSPORTATION BRITISH SOUTH COAST REGION
OR CONSTRUCTION	ILW	
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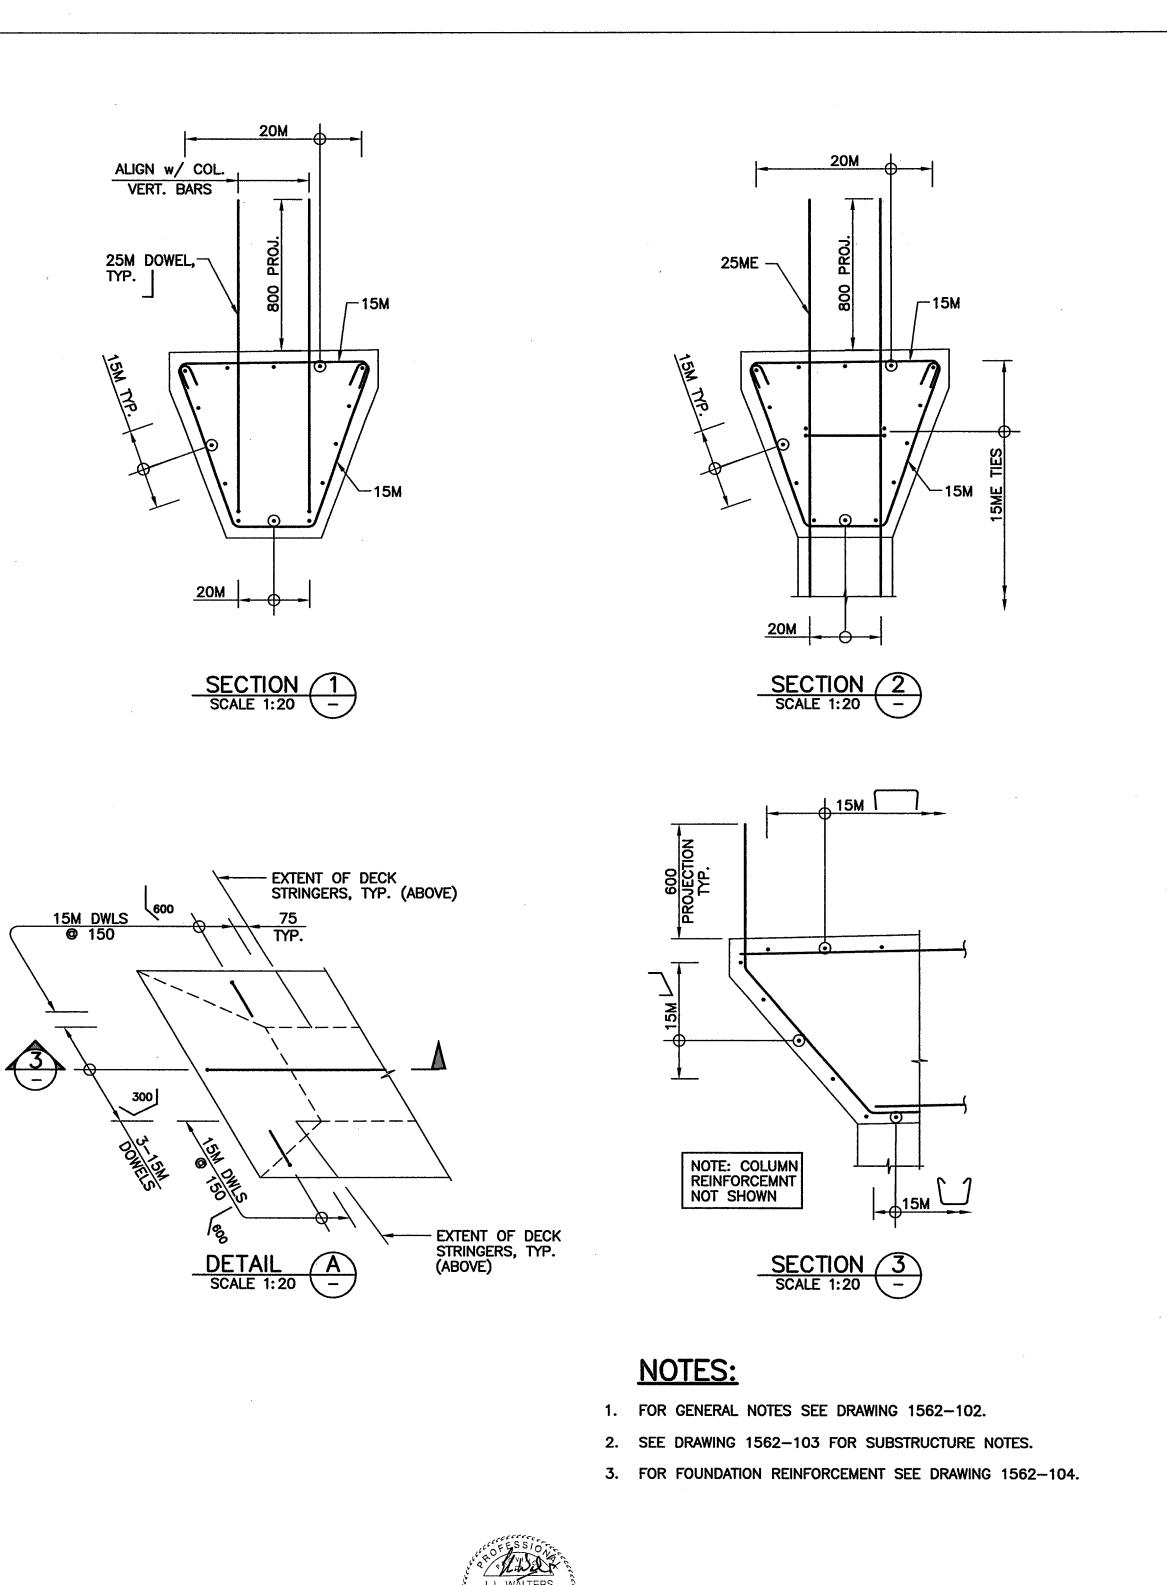
--SMOOTH TROWEL FINISH TYP 1% ALL PIERS

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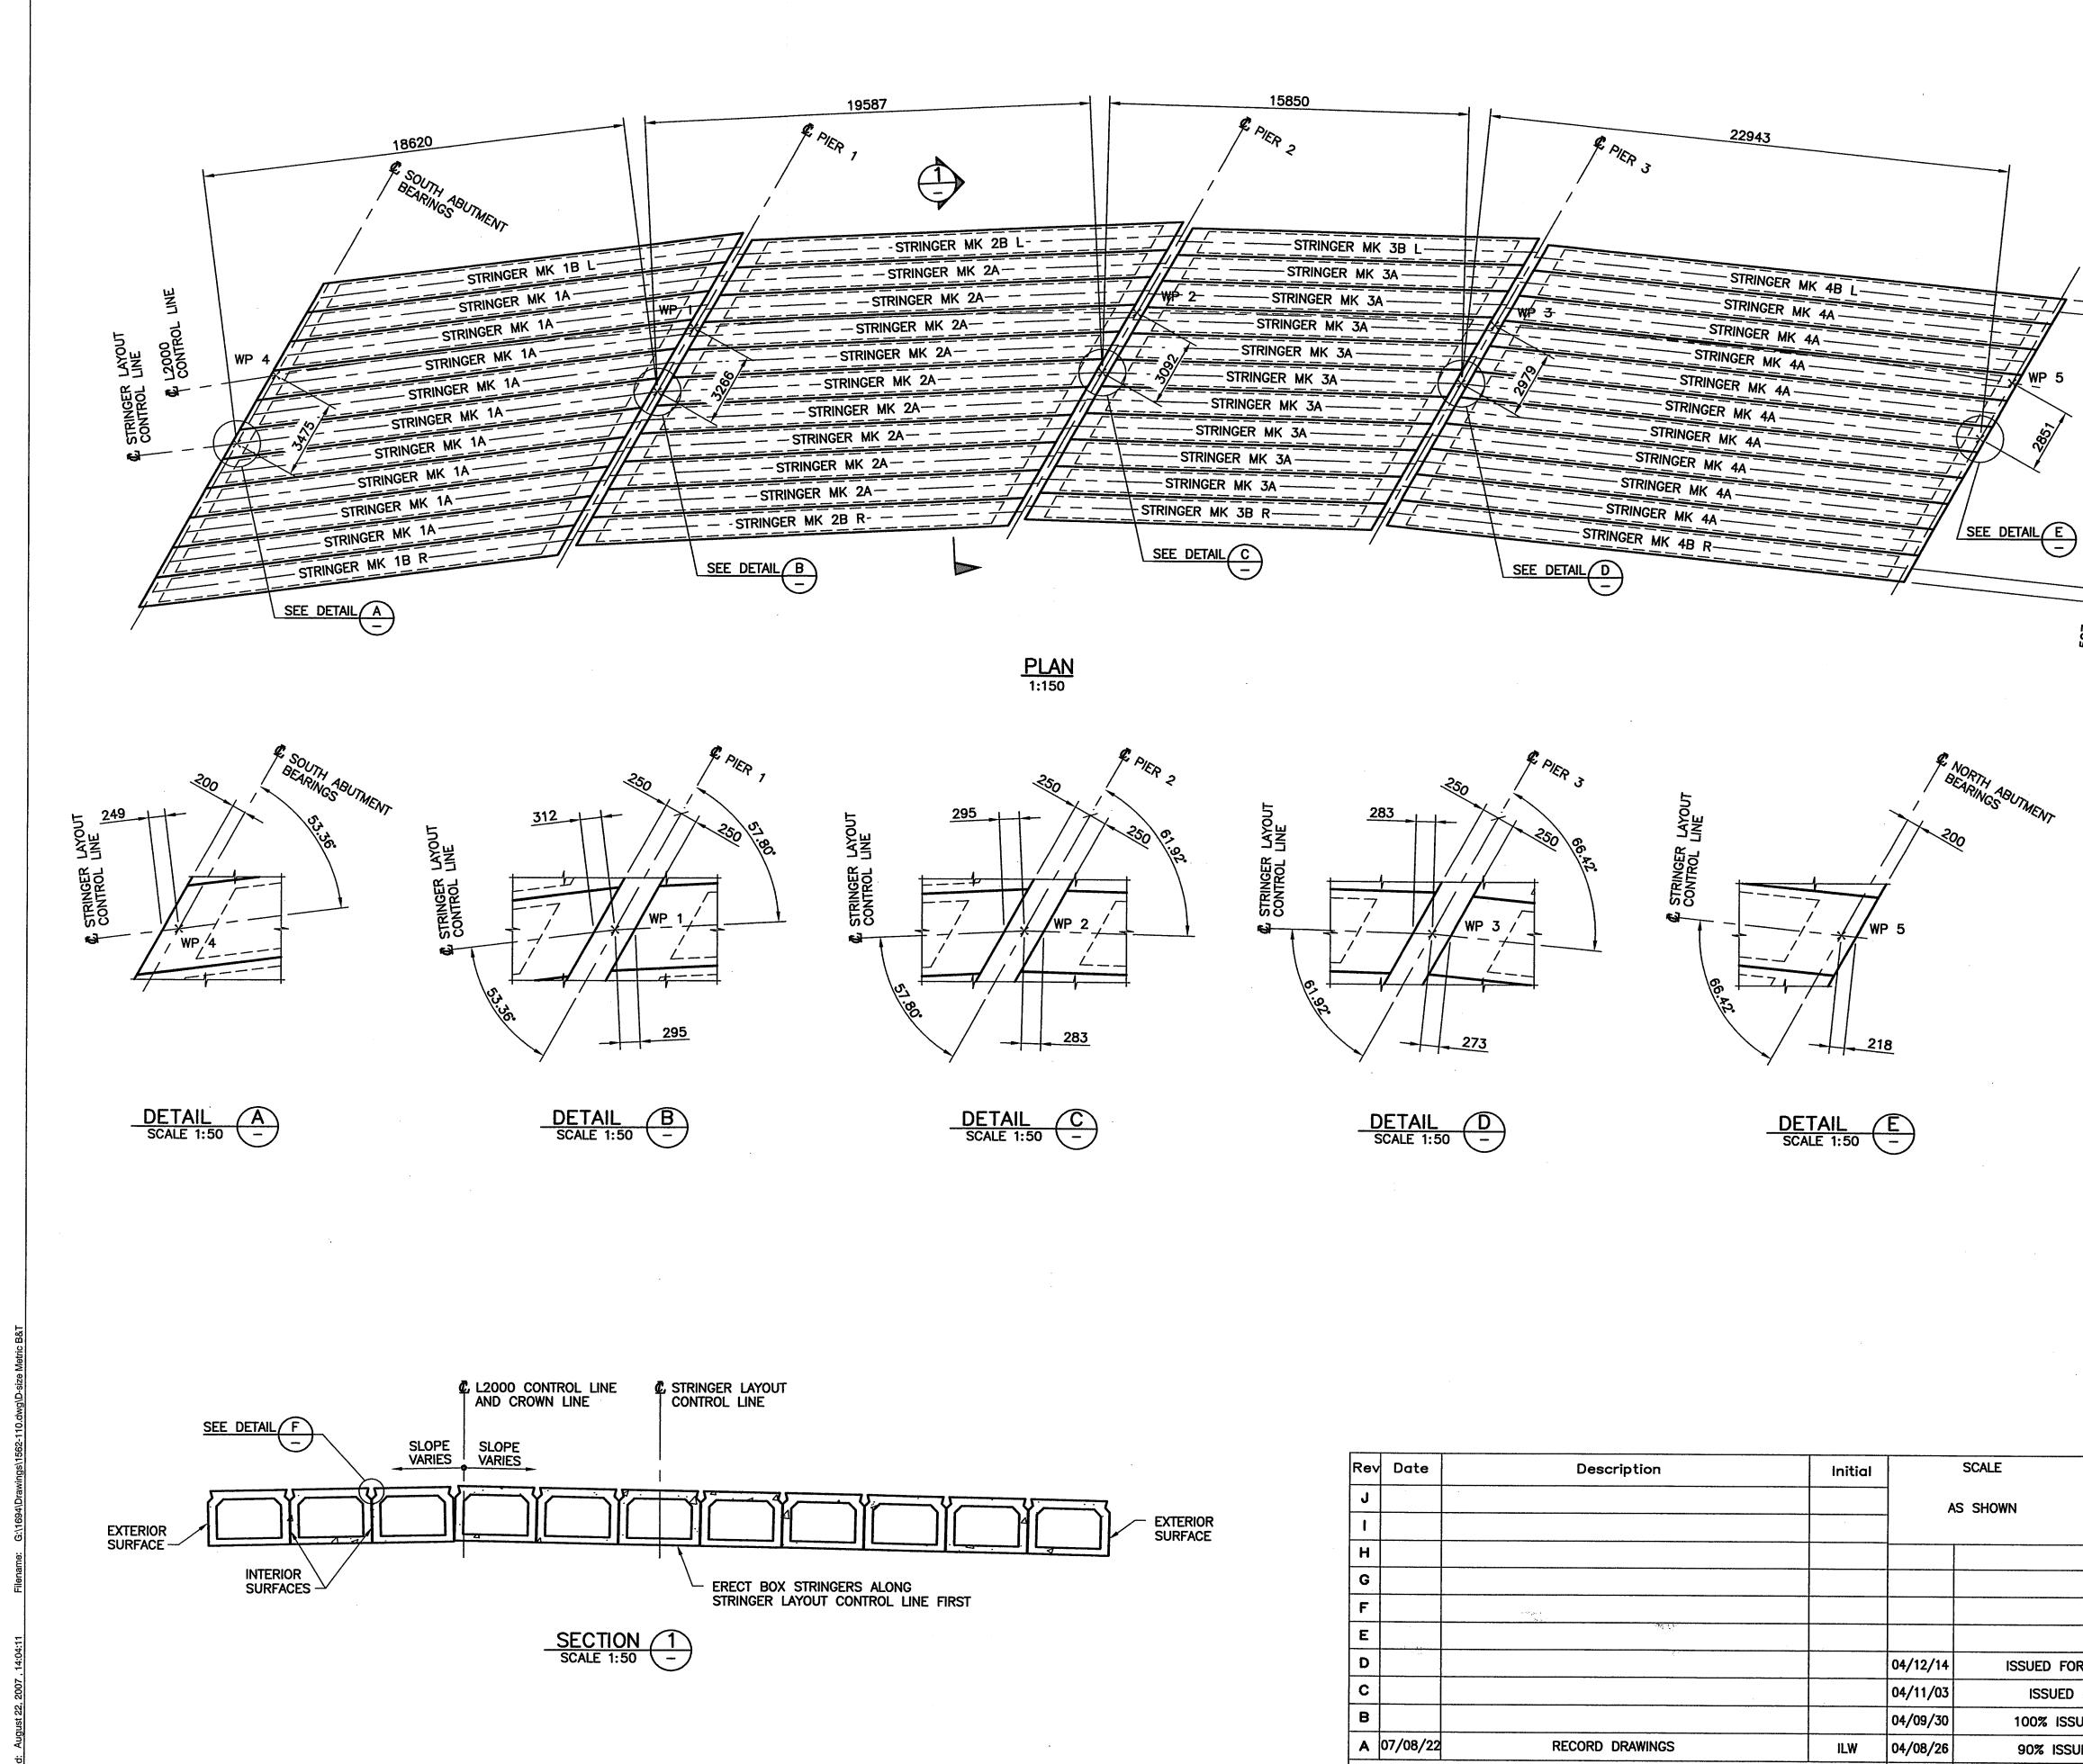


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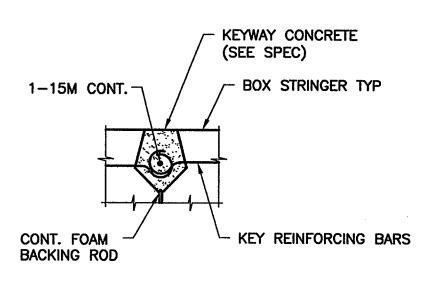
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BOX STRINGER NOTES:

- 1. PRESTRESSING STRANDS SHALL BE 13 DIA. 7 WIRE. UNCOATED LOW RELAXATION STRANDS CONFORMING TO CSA G279, GRADE 1860 MPa. MINIMUM TENSILE FORCE IMMEDIATELY BEFORE RELEASE OF STRANDS SHALL BE 138 KN.
- 2. CONCRETE SHALL HAVE A 35 MPa MINIMUM COMPRESSIVE STRENGTH AT TIME OF RELEASE. MINIMUM COMPRESSIVE STRENGTH AT 28 DAYS SHALL BE 45MPa.
- 3. REINFORCING STEEL SHALL BE IN ACCORDANCE WITH CSA G30.18M GRADE 400W MPa.
- 4. REINFORCING STEEL SHALL HAVE 35 MINIMUM COVER UNLESS NOTED OTHERWISE. PRESTRESSING STRANDS SHALL HAVE 45 MINIMUM COVER UNLESS NOTED OTHERWISE.
- LAP OF BARS FOR SPLICES TO BE 40 x BAR DIAMETER UNLESS NOTED 5. OTHERWISE. SPLICES TO BE STAGGERED SO THAT NOT MORE THAN EVERY SECOND BAR IS SPLICED AT ANY CROSS SECTION.
- 6. TOP SURFACE OF ALL STRINGERS SHALL BE SANDBLASTED TO EXPOSE AGGREGATE AND PROVIDE 6mm AMPLITUDE. OUTER SURFACES OF EXTERIOR STRINGERS SHALL RECEIVE A CLASS 2 RUBBED FINISH. ALL OTHER SURFACES SHALL BE SMOOTH FORM FINISH.
- 7. LIFTING DEVICES BY OTHERS SHALL BE LOCATED ONLY OVER BEARINGS. ONLY VERTICAL LIFTS SHALL BE PERMITTED. SUDDEN IMPACT LOADS ON THE STRINGER SHALL BE PREVENTED.
- 8. STRINGERS SHALL BE TEMPORARILY SUPPORTED ONLY AT BEARING LOCATIONS.
- 9. ALL PLAN DIMENSIONS ARE HORIZONTAL. ALLOWANCE SHALL BE MADE FOR ELASTIC SHORTENING, SHRINKAGE, CREEP AND SLOPE. ENDS OF STRINGERS SHALL BE SET VERTICAL DURING CASTING.
- 10. ELEVATION OF STRINGERS TO BE SURVEYED BY THE CONTRACTOR AT 2m INTERVALS AFTER STRINGER ERECTION. DECK THICKNESS SHALL BE ADJUSTED TO ACCOUNT FOR STRINGER DEFLECTION AND CAMBER.
- 11. INTERIOR FORMWORK SHALL ALLOW FREE MOVEMENT OF WATER TO THE DRAIN HOLES.
- 12. UNLESS NOTED OTHERWISE, BOTTOM EDGES OF STRINGERS SHALL BE CHAMFERED 20mm.
- 13. ALL STRINGERS TO BE CAST A MINIMUM OF 30 DAYS PRIOR TO ERECTION OR AT AN EARLY STAGE SUBJECT TO APPROVAL BY THE ENGINEER.



DETAIL F SCALE 1:10 -

ABUTMENT

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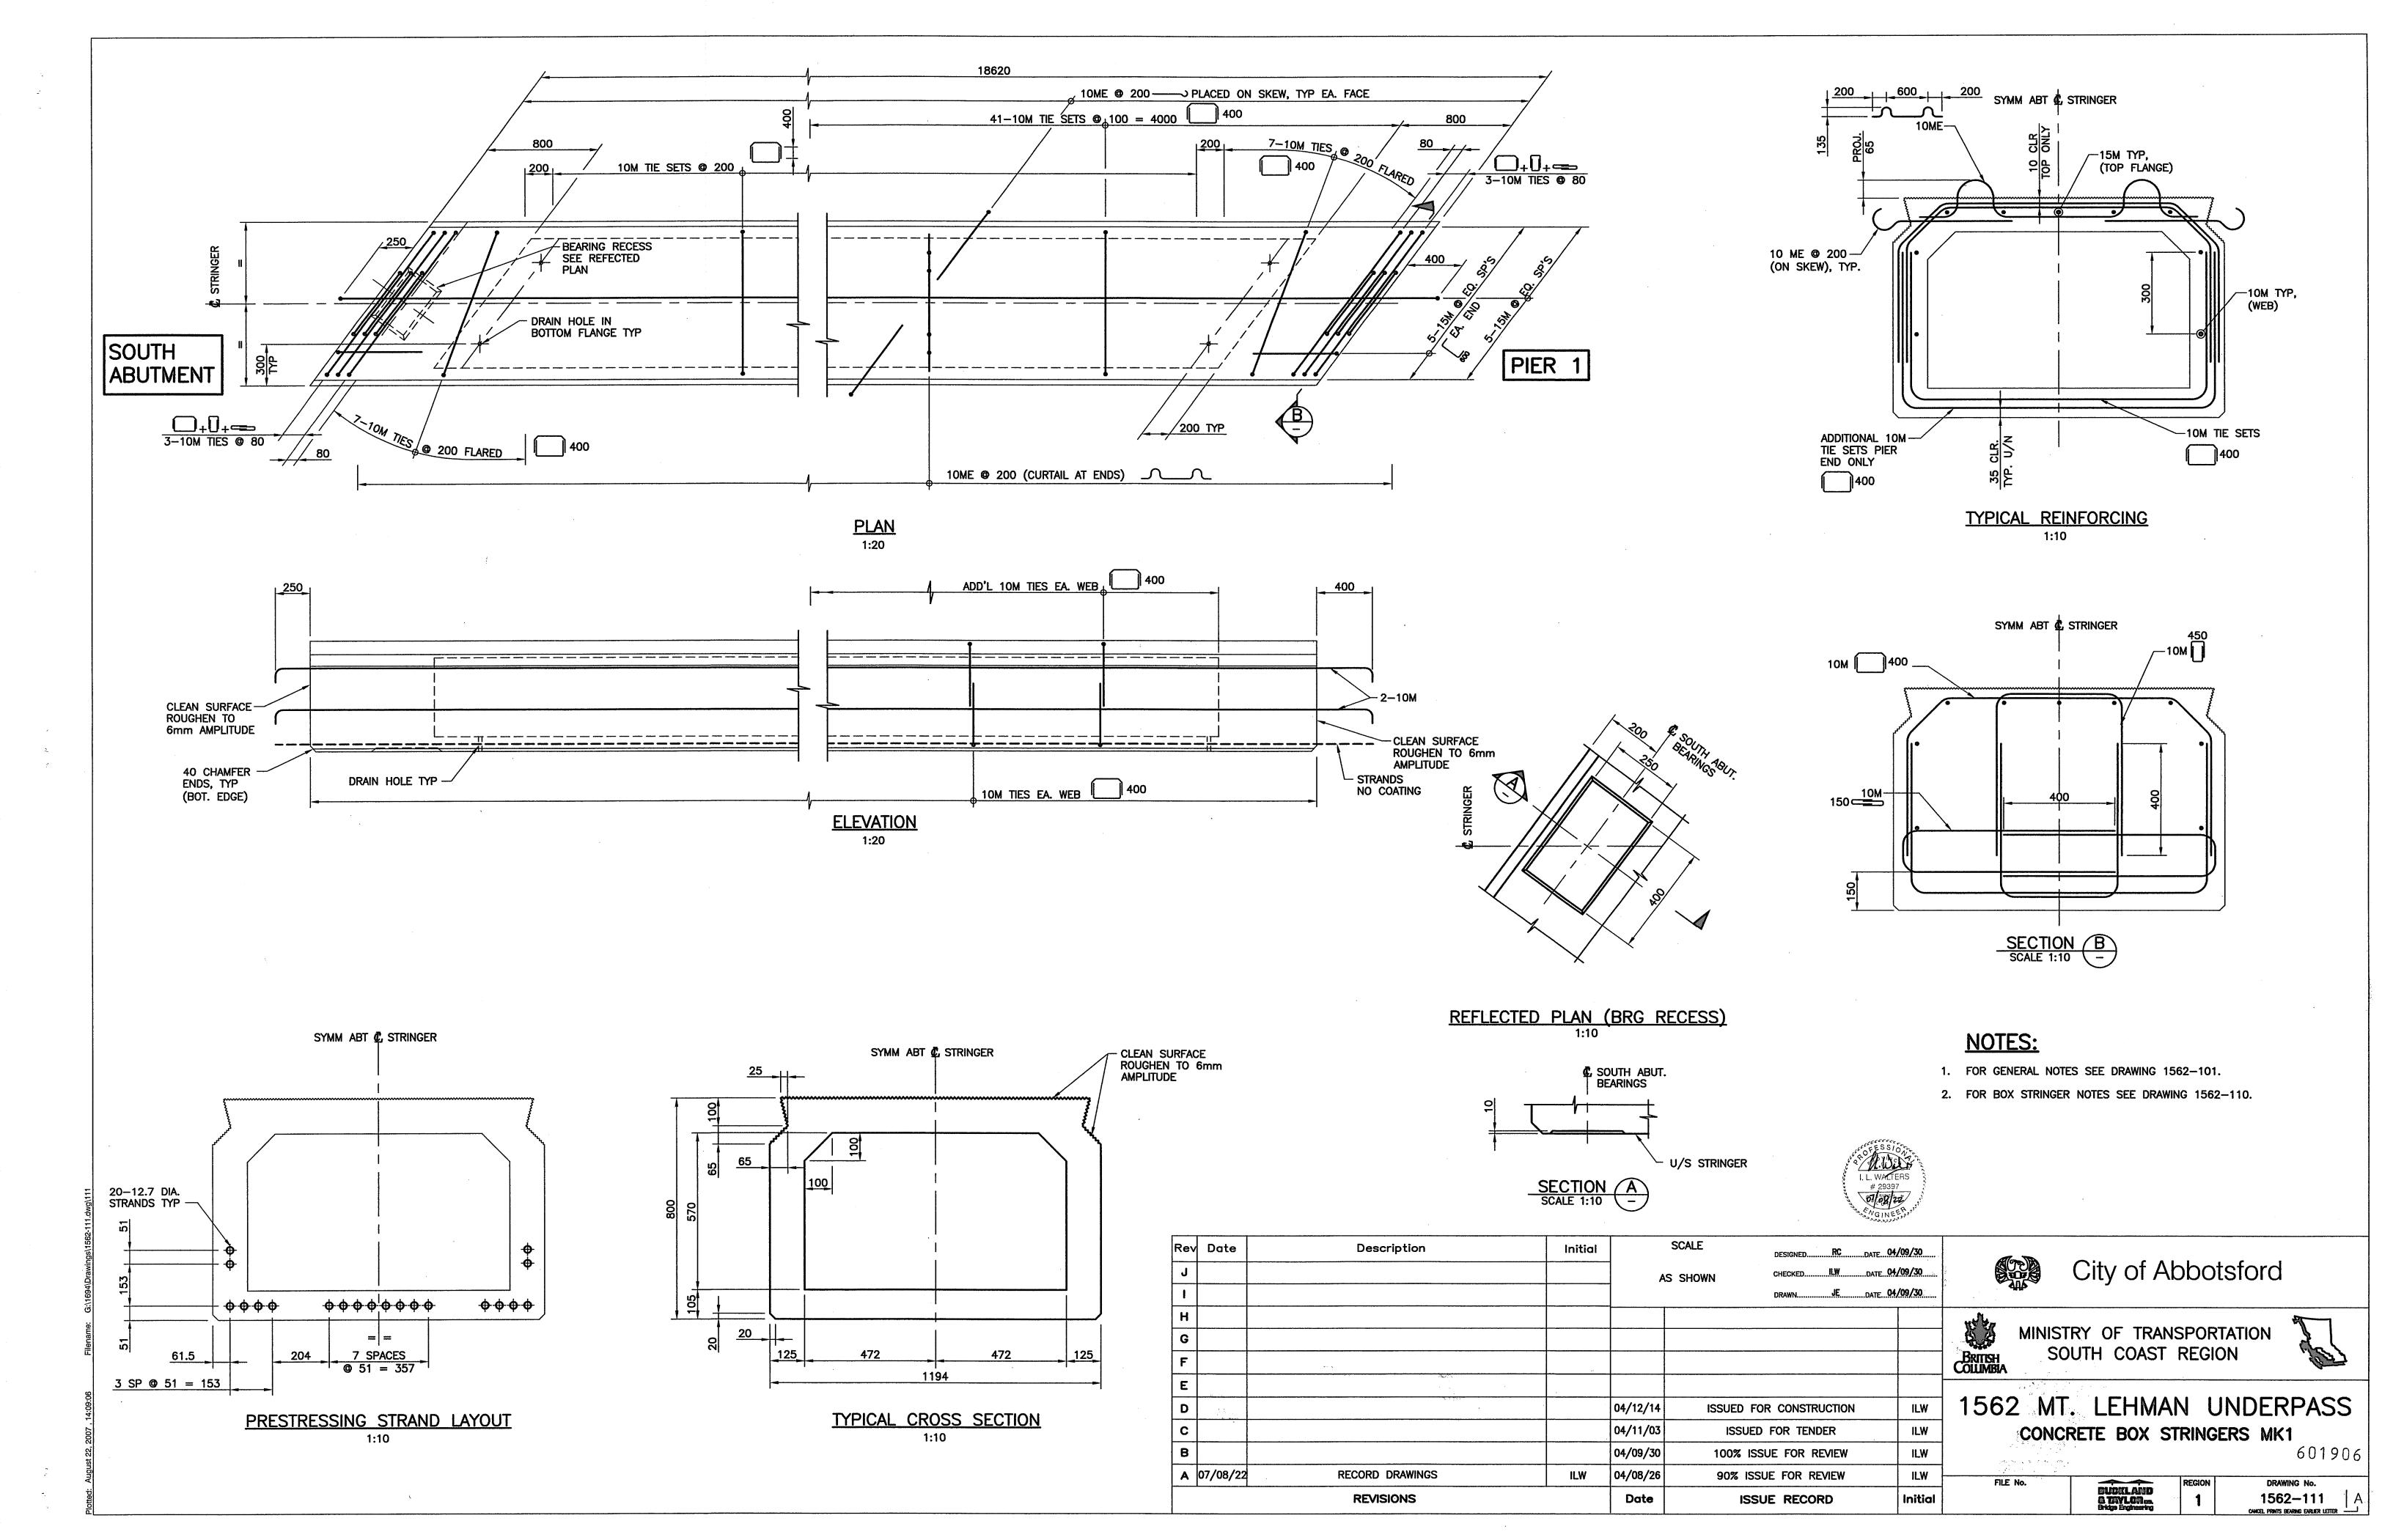
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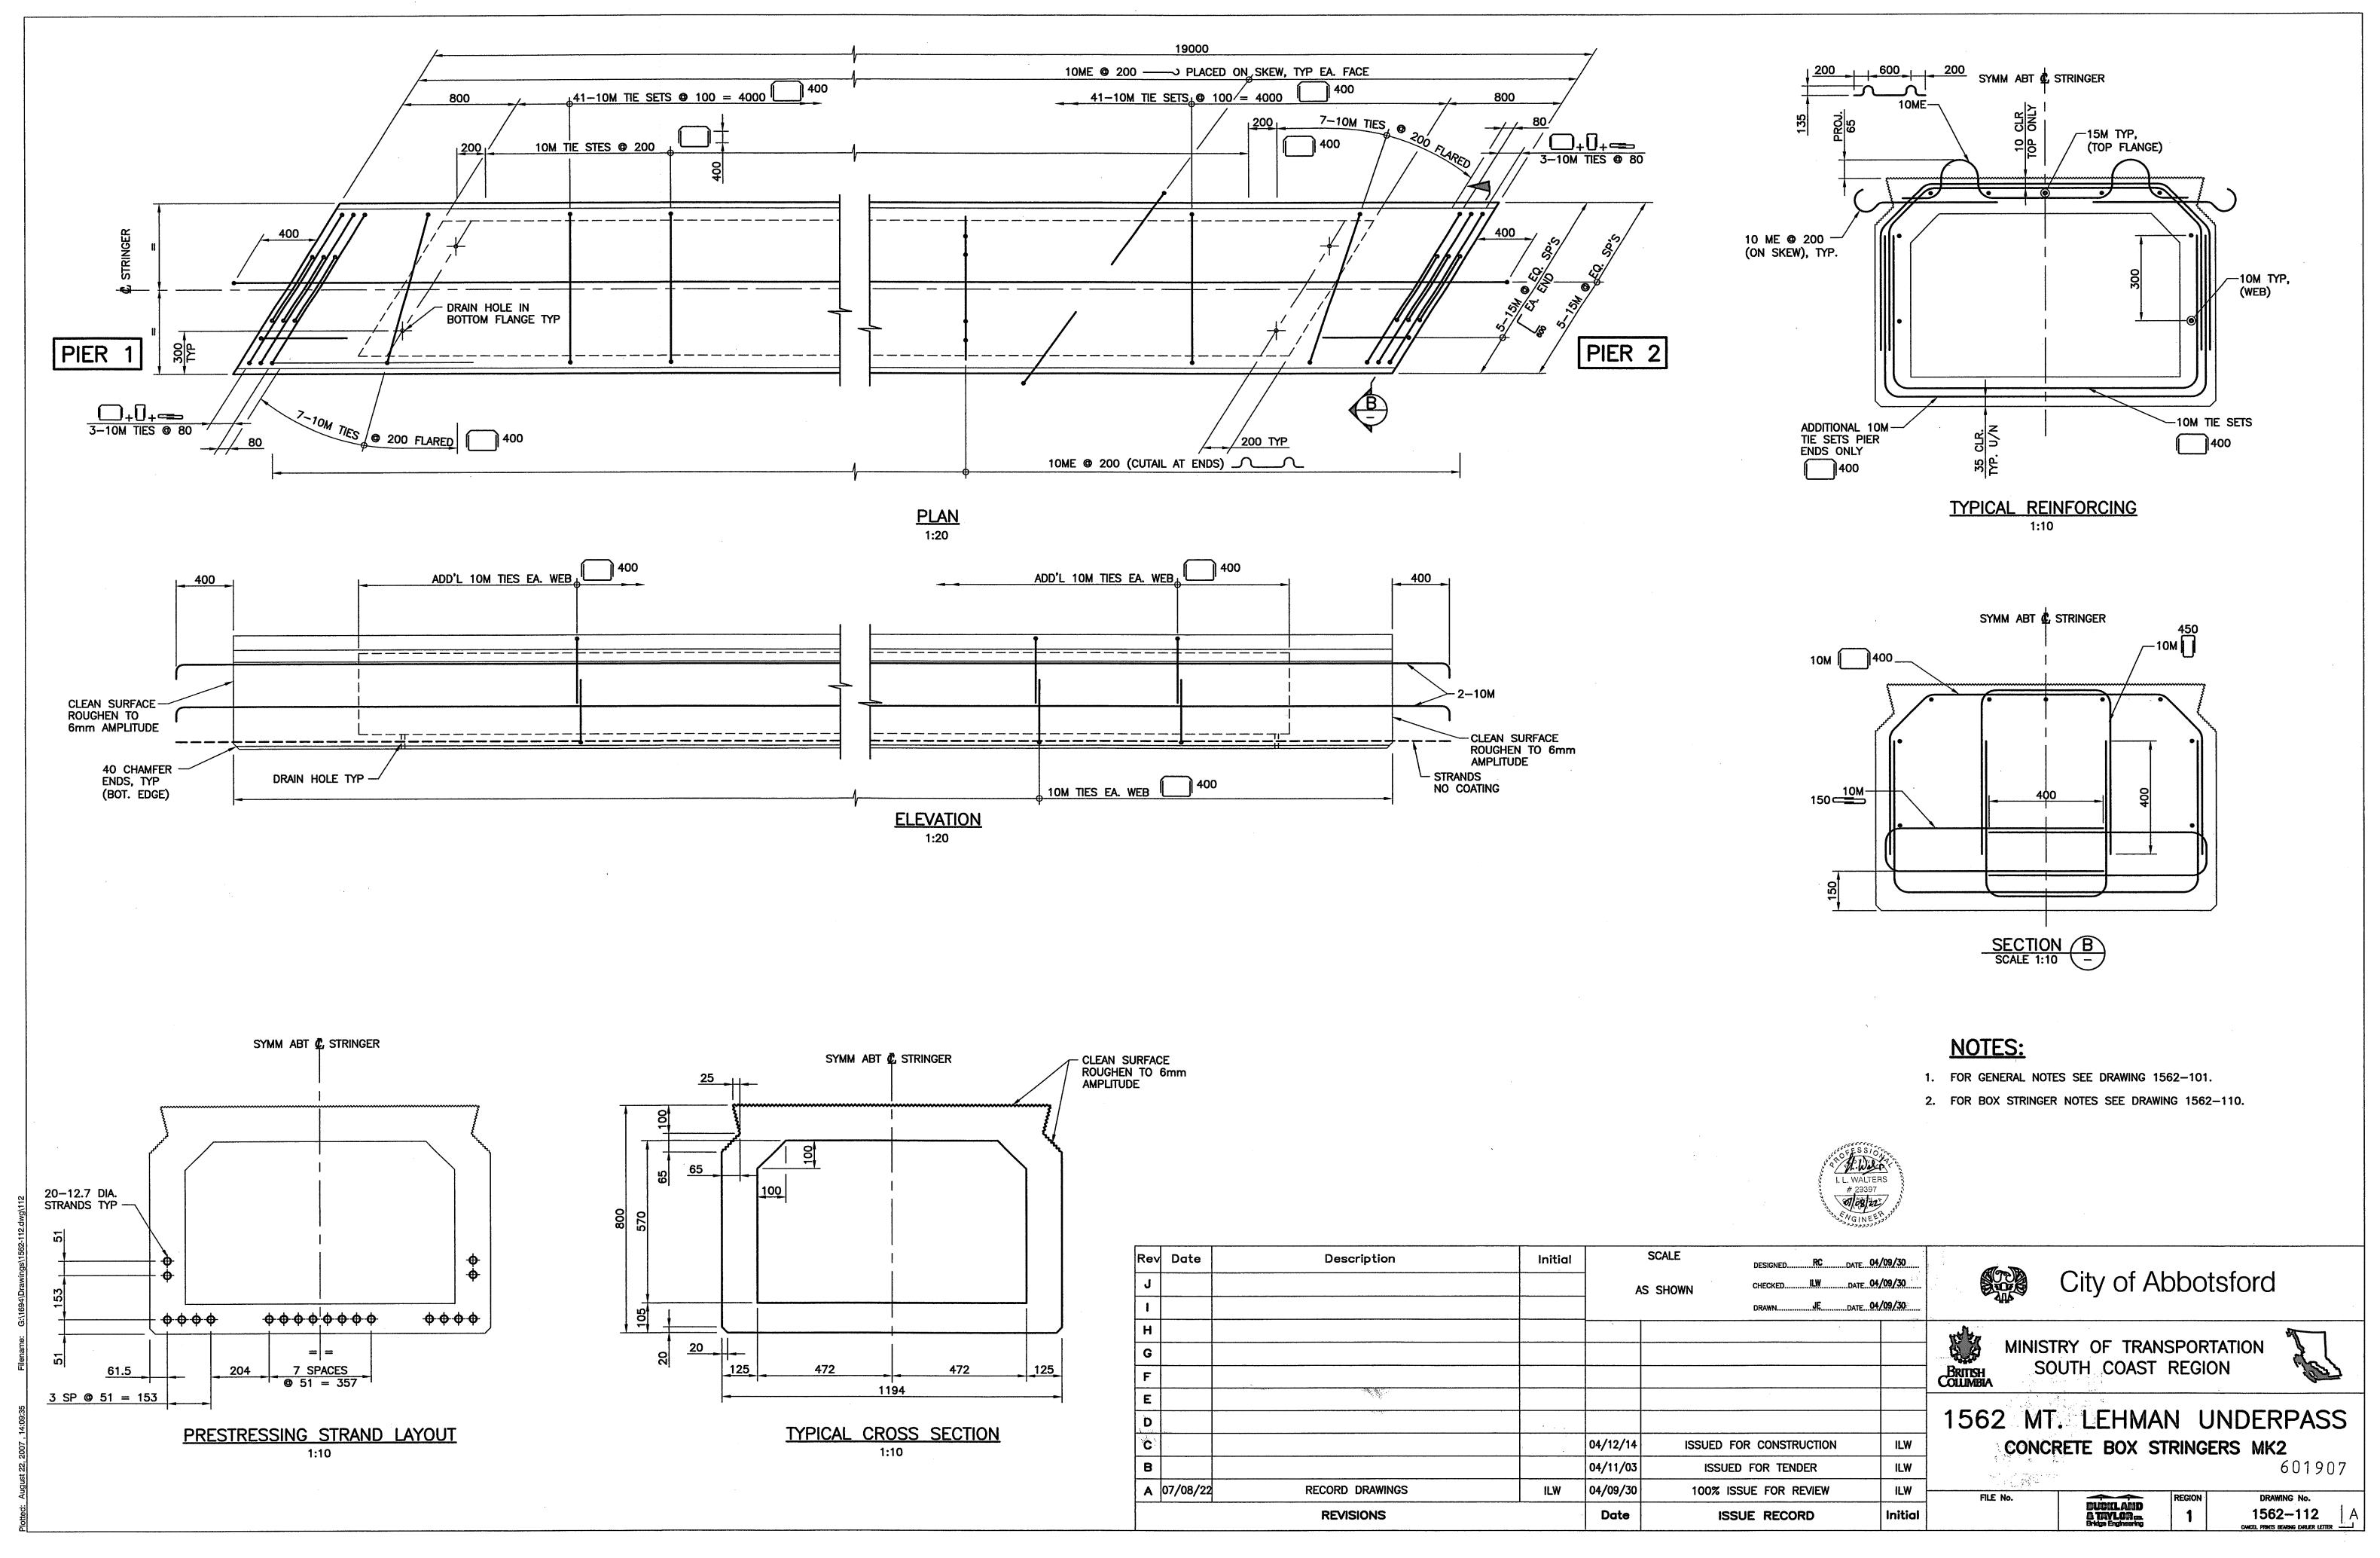
- 1. FOR GENERAL NOTES SEE DRAWING 1562-102.
- 2. FOR BOX STRINGER DETAILS SEE DRAWINGS 1562-111, 112, 113 & 114.

CANCEL PRINTS BEARING EARLIER LETTER

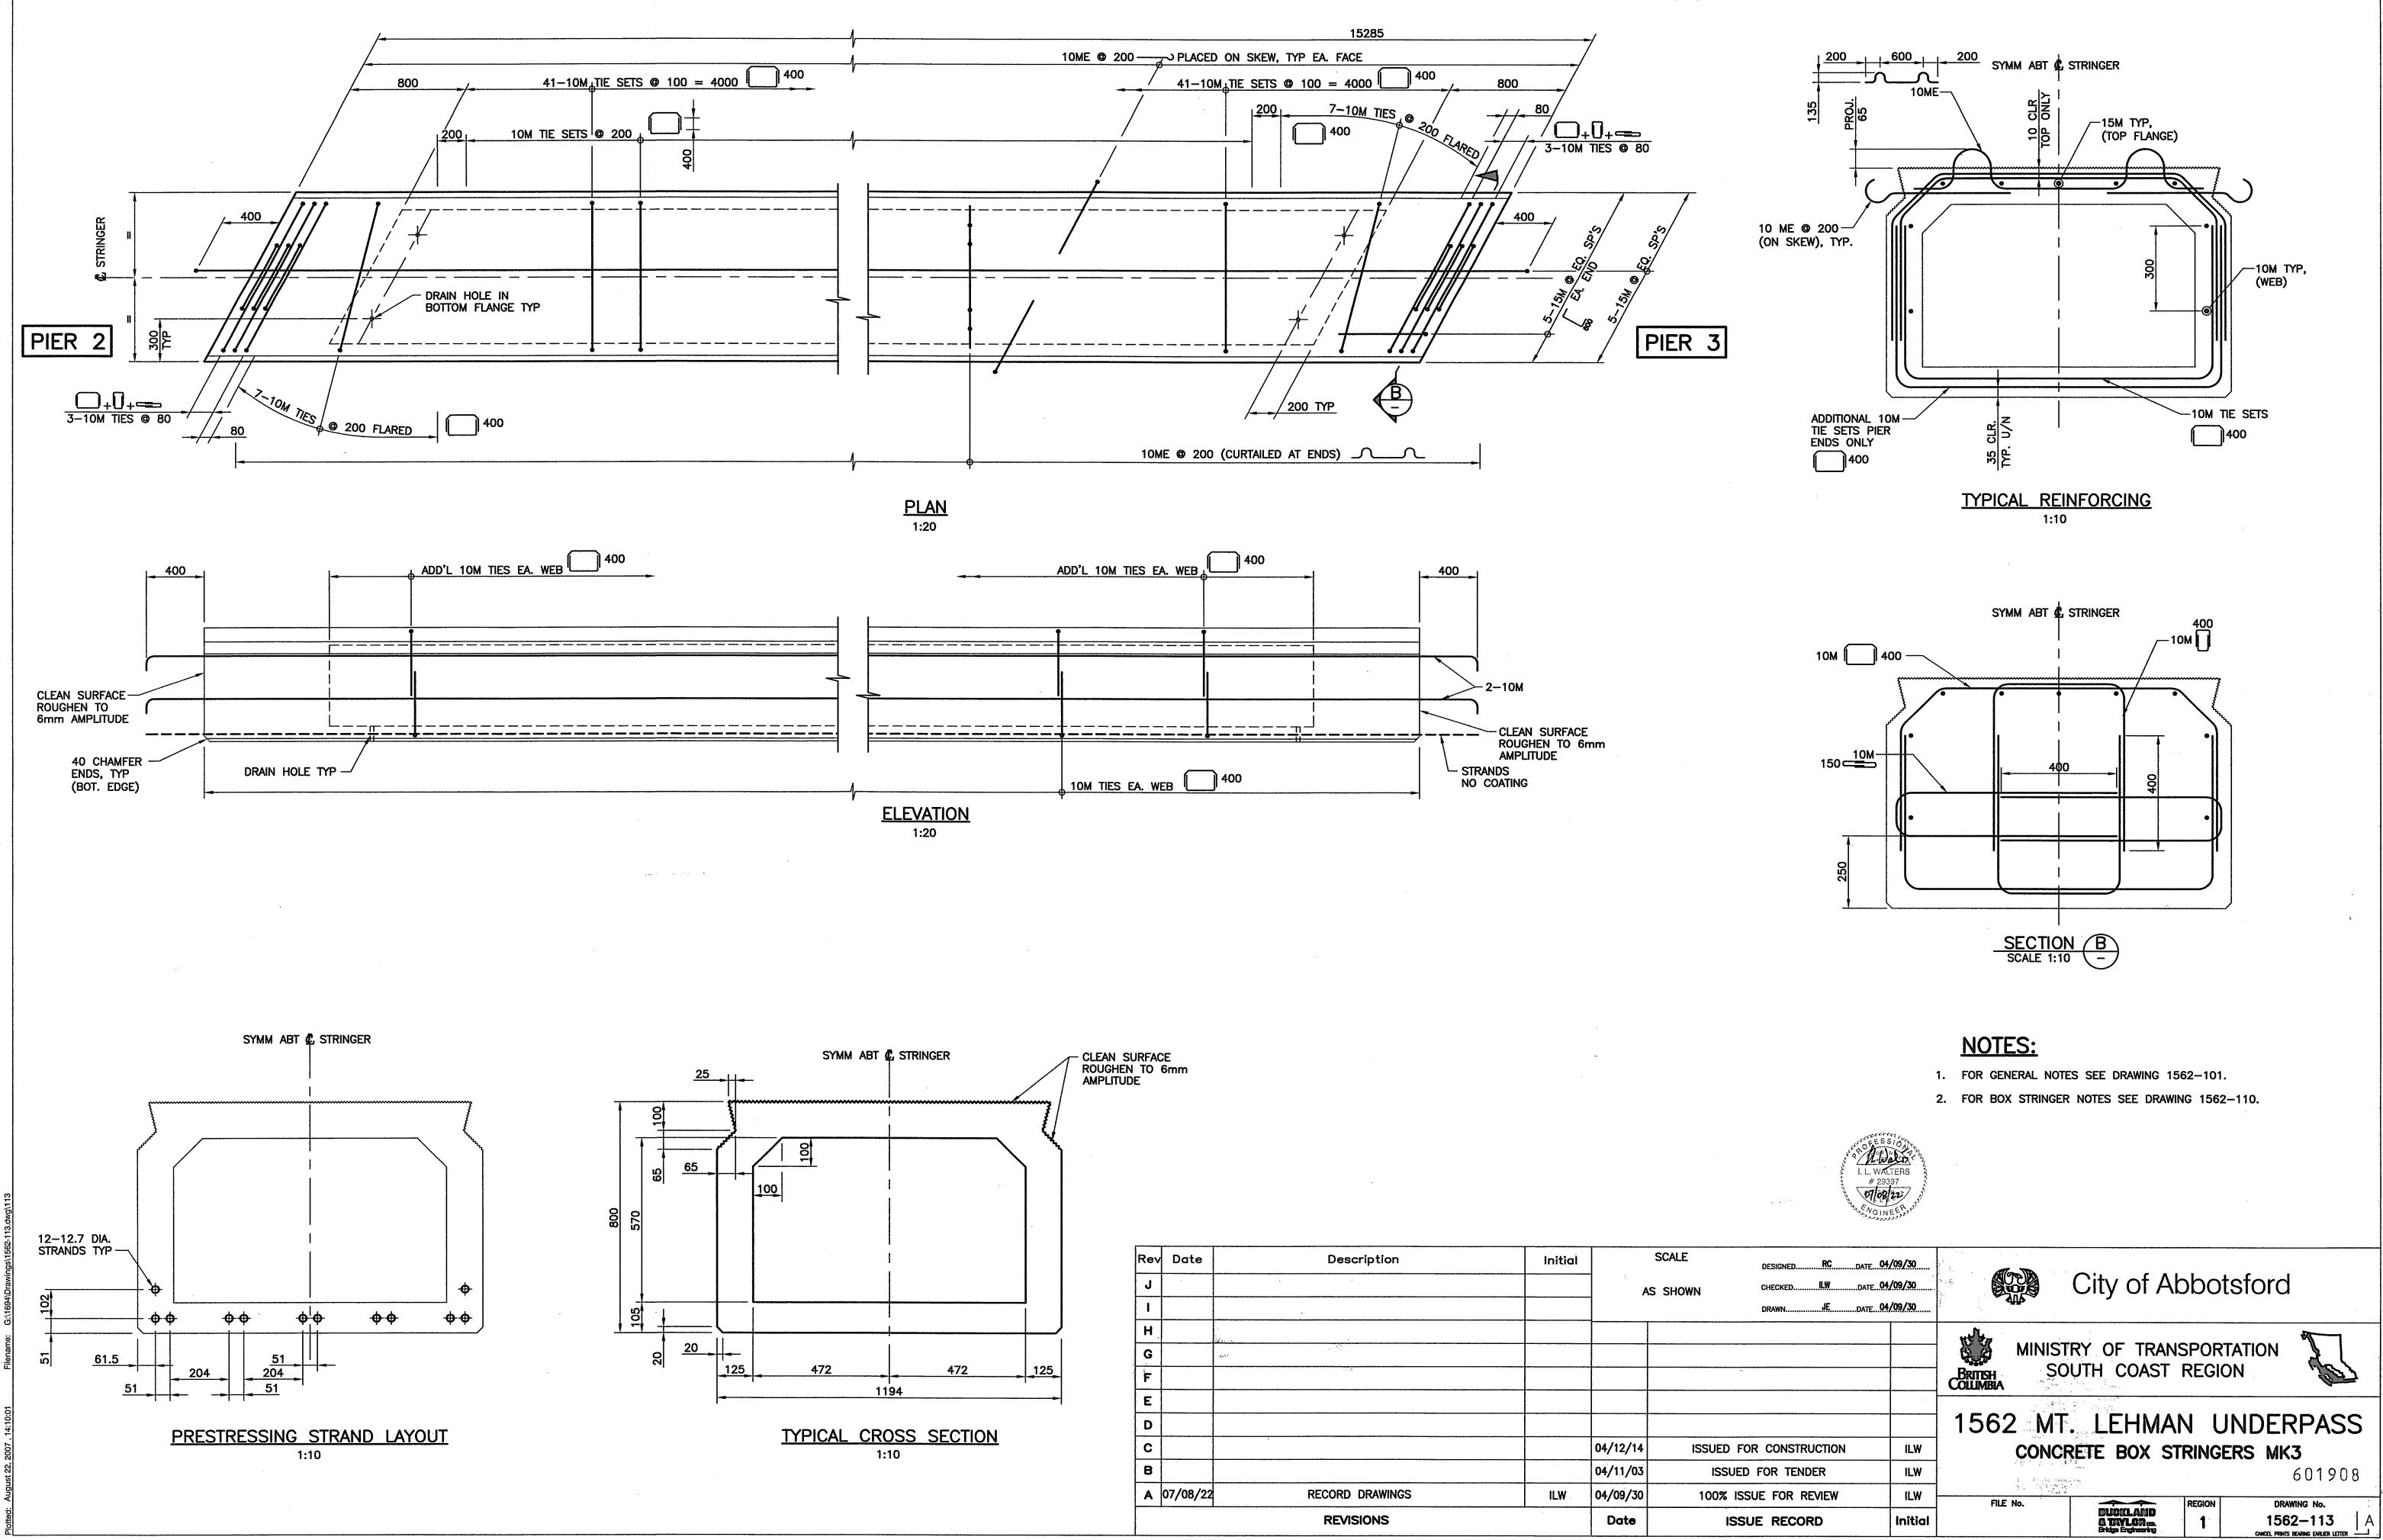


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IE FOR REVIEW	ILW	FILE No.	<u> </u>	0501011		
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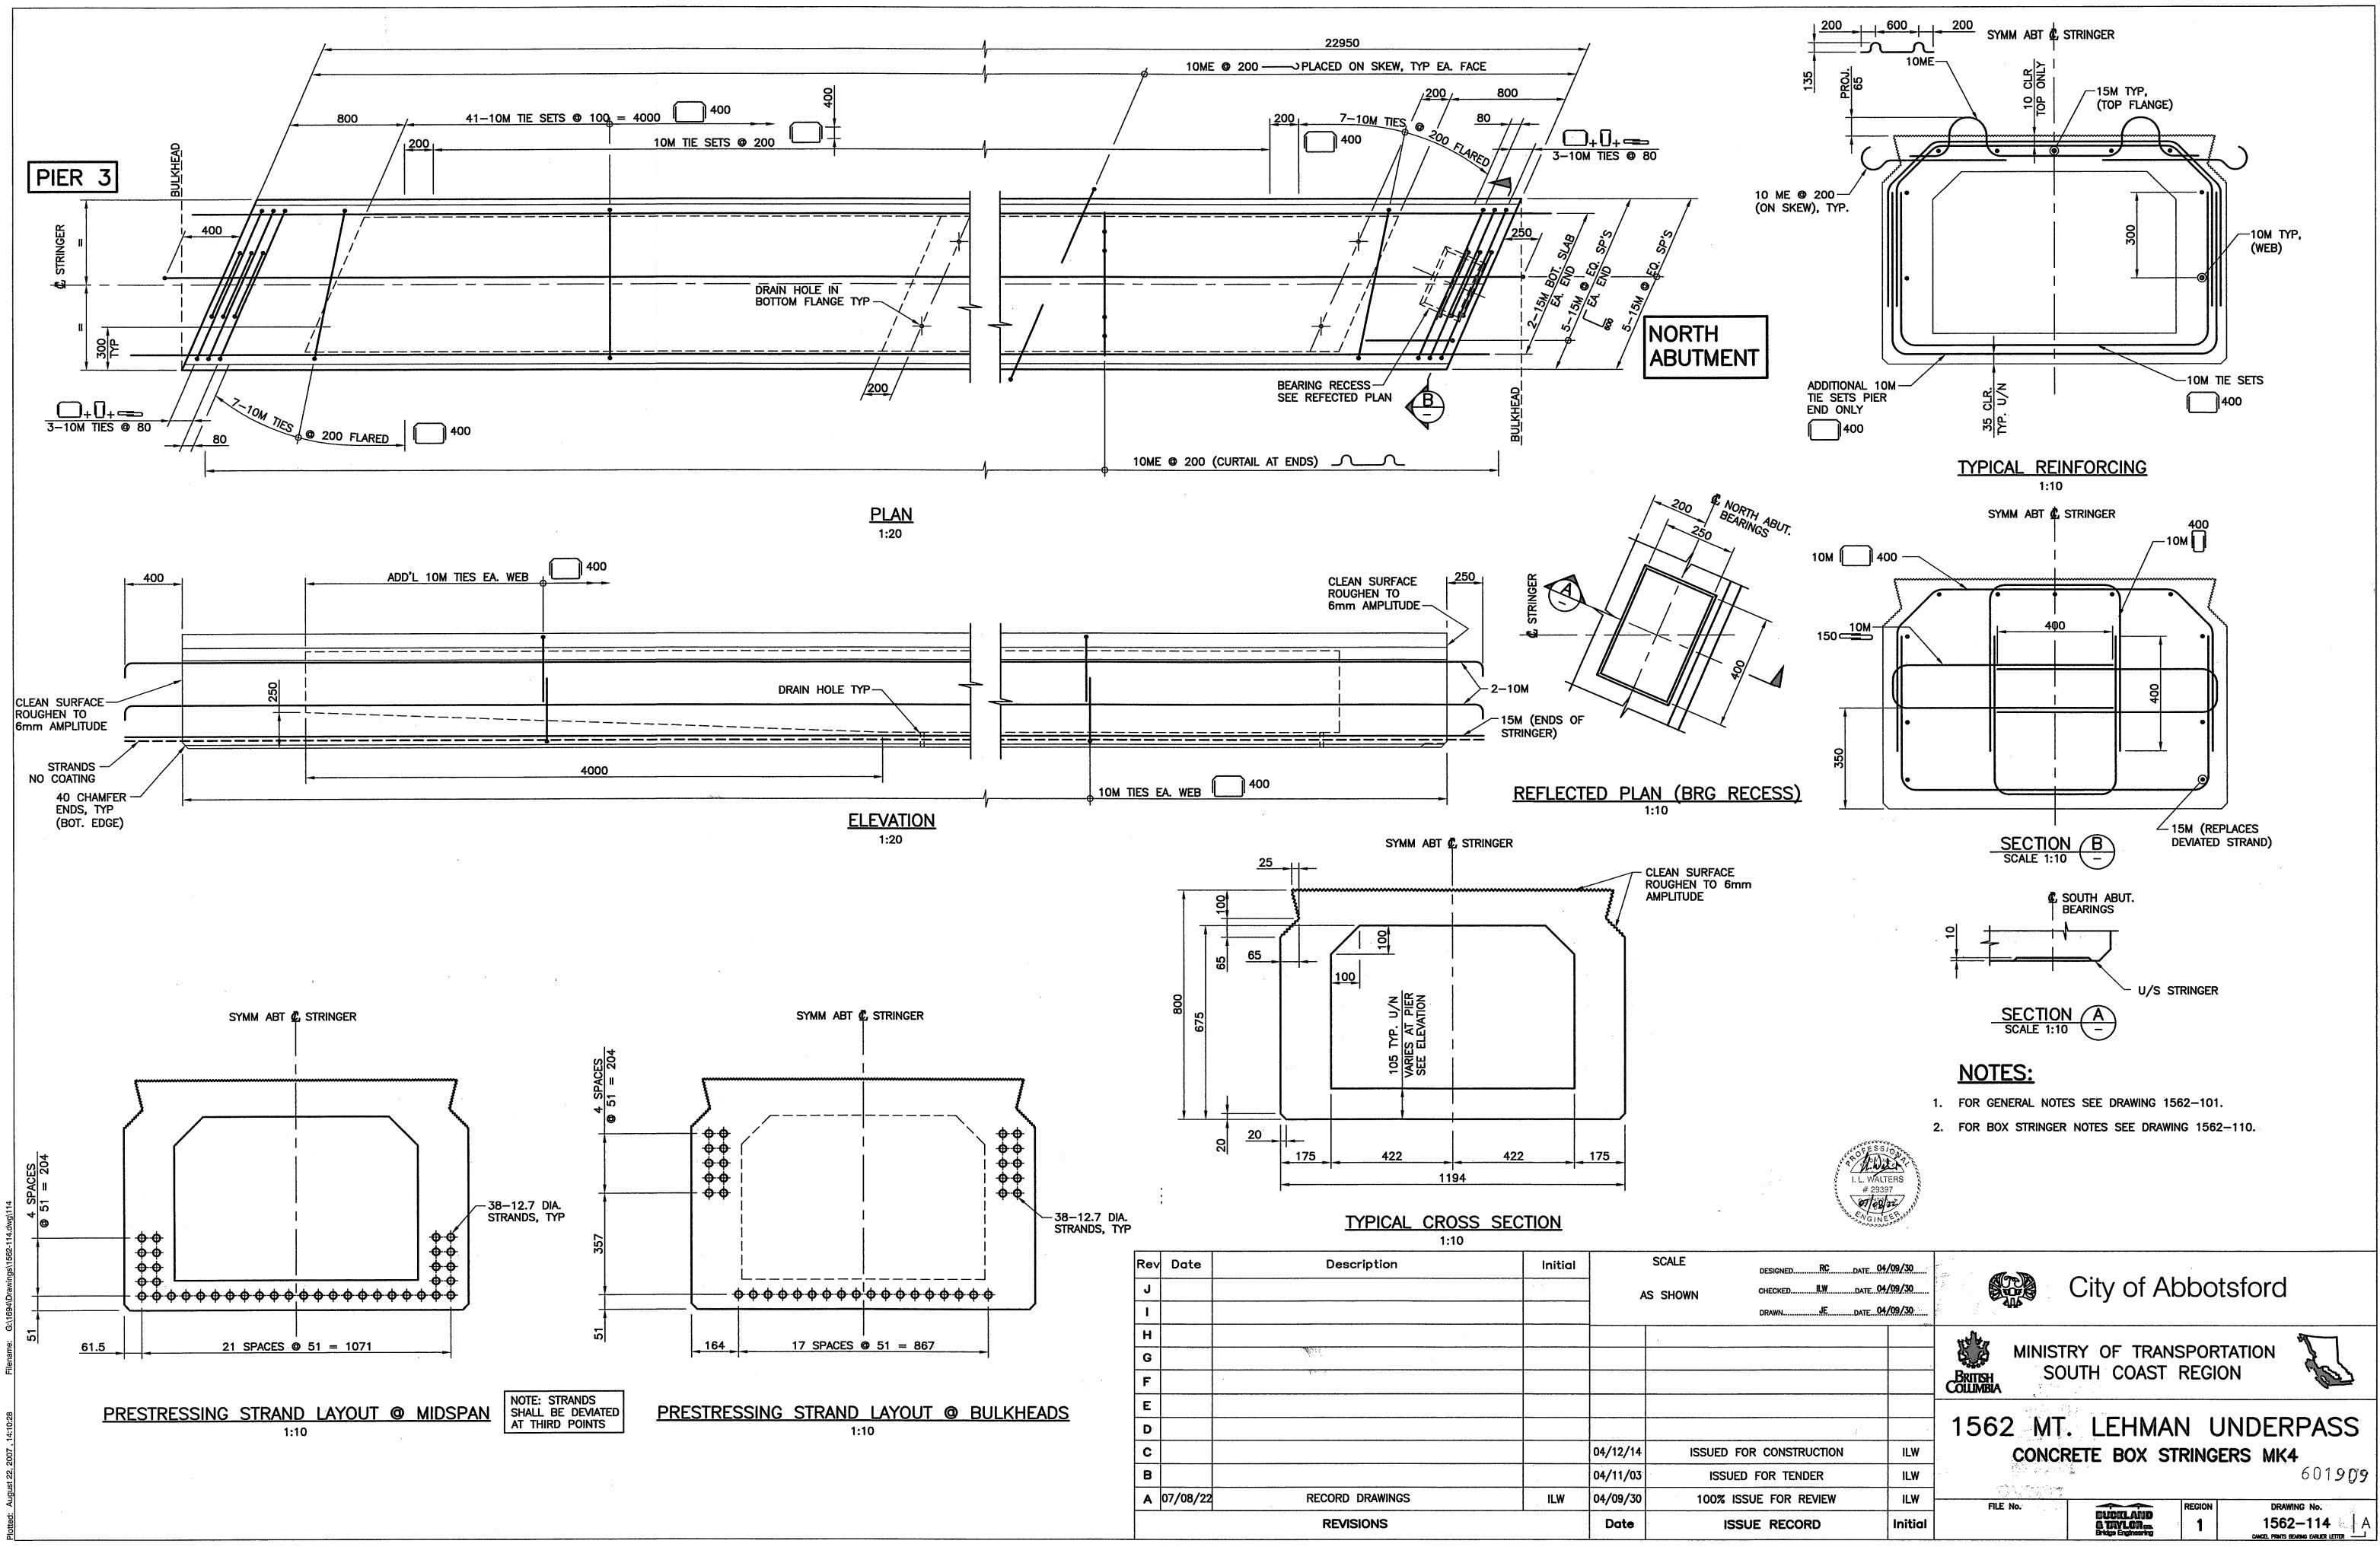




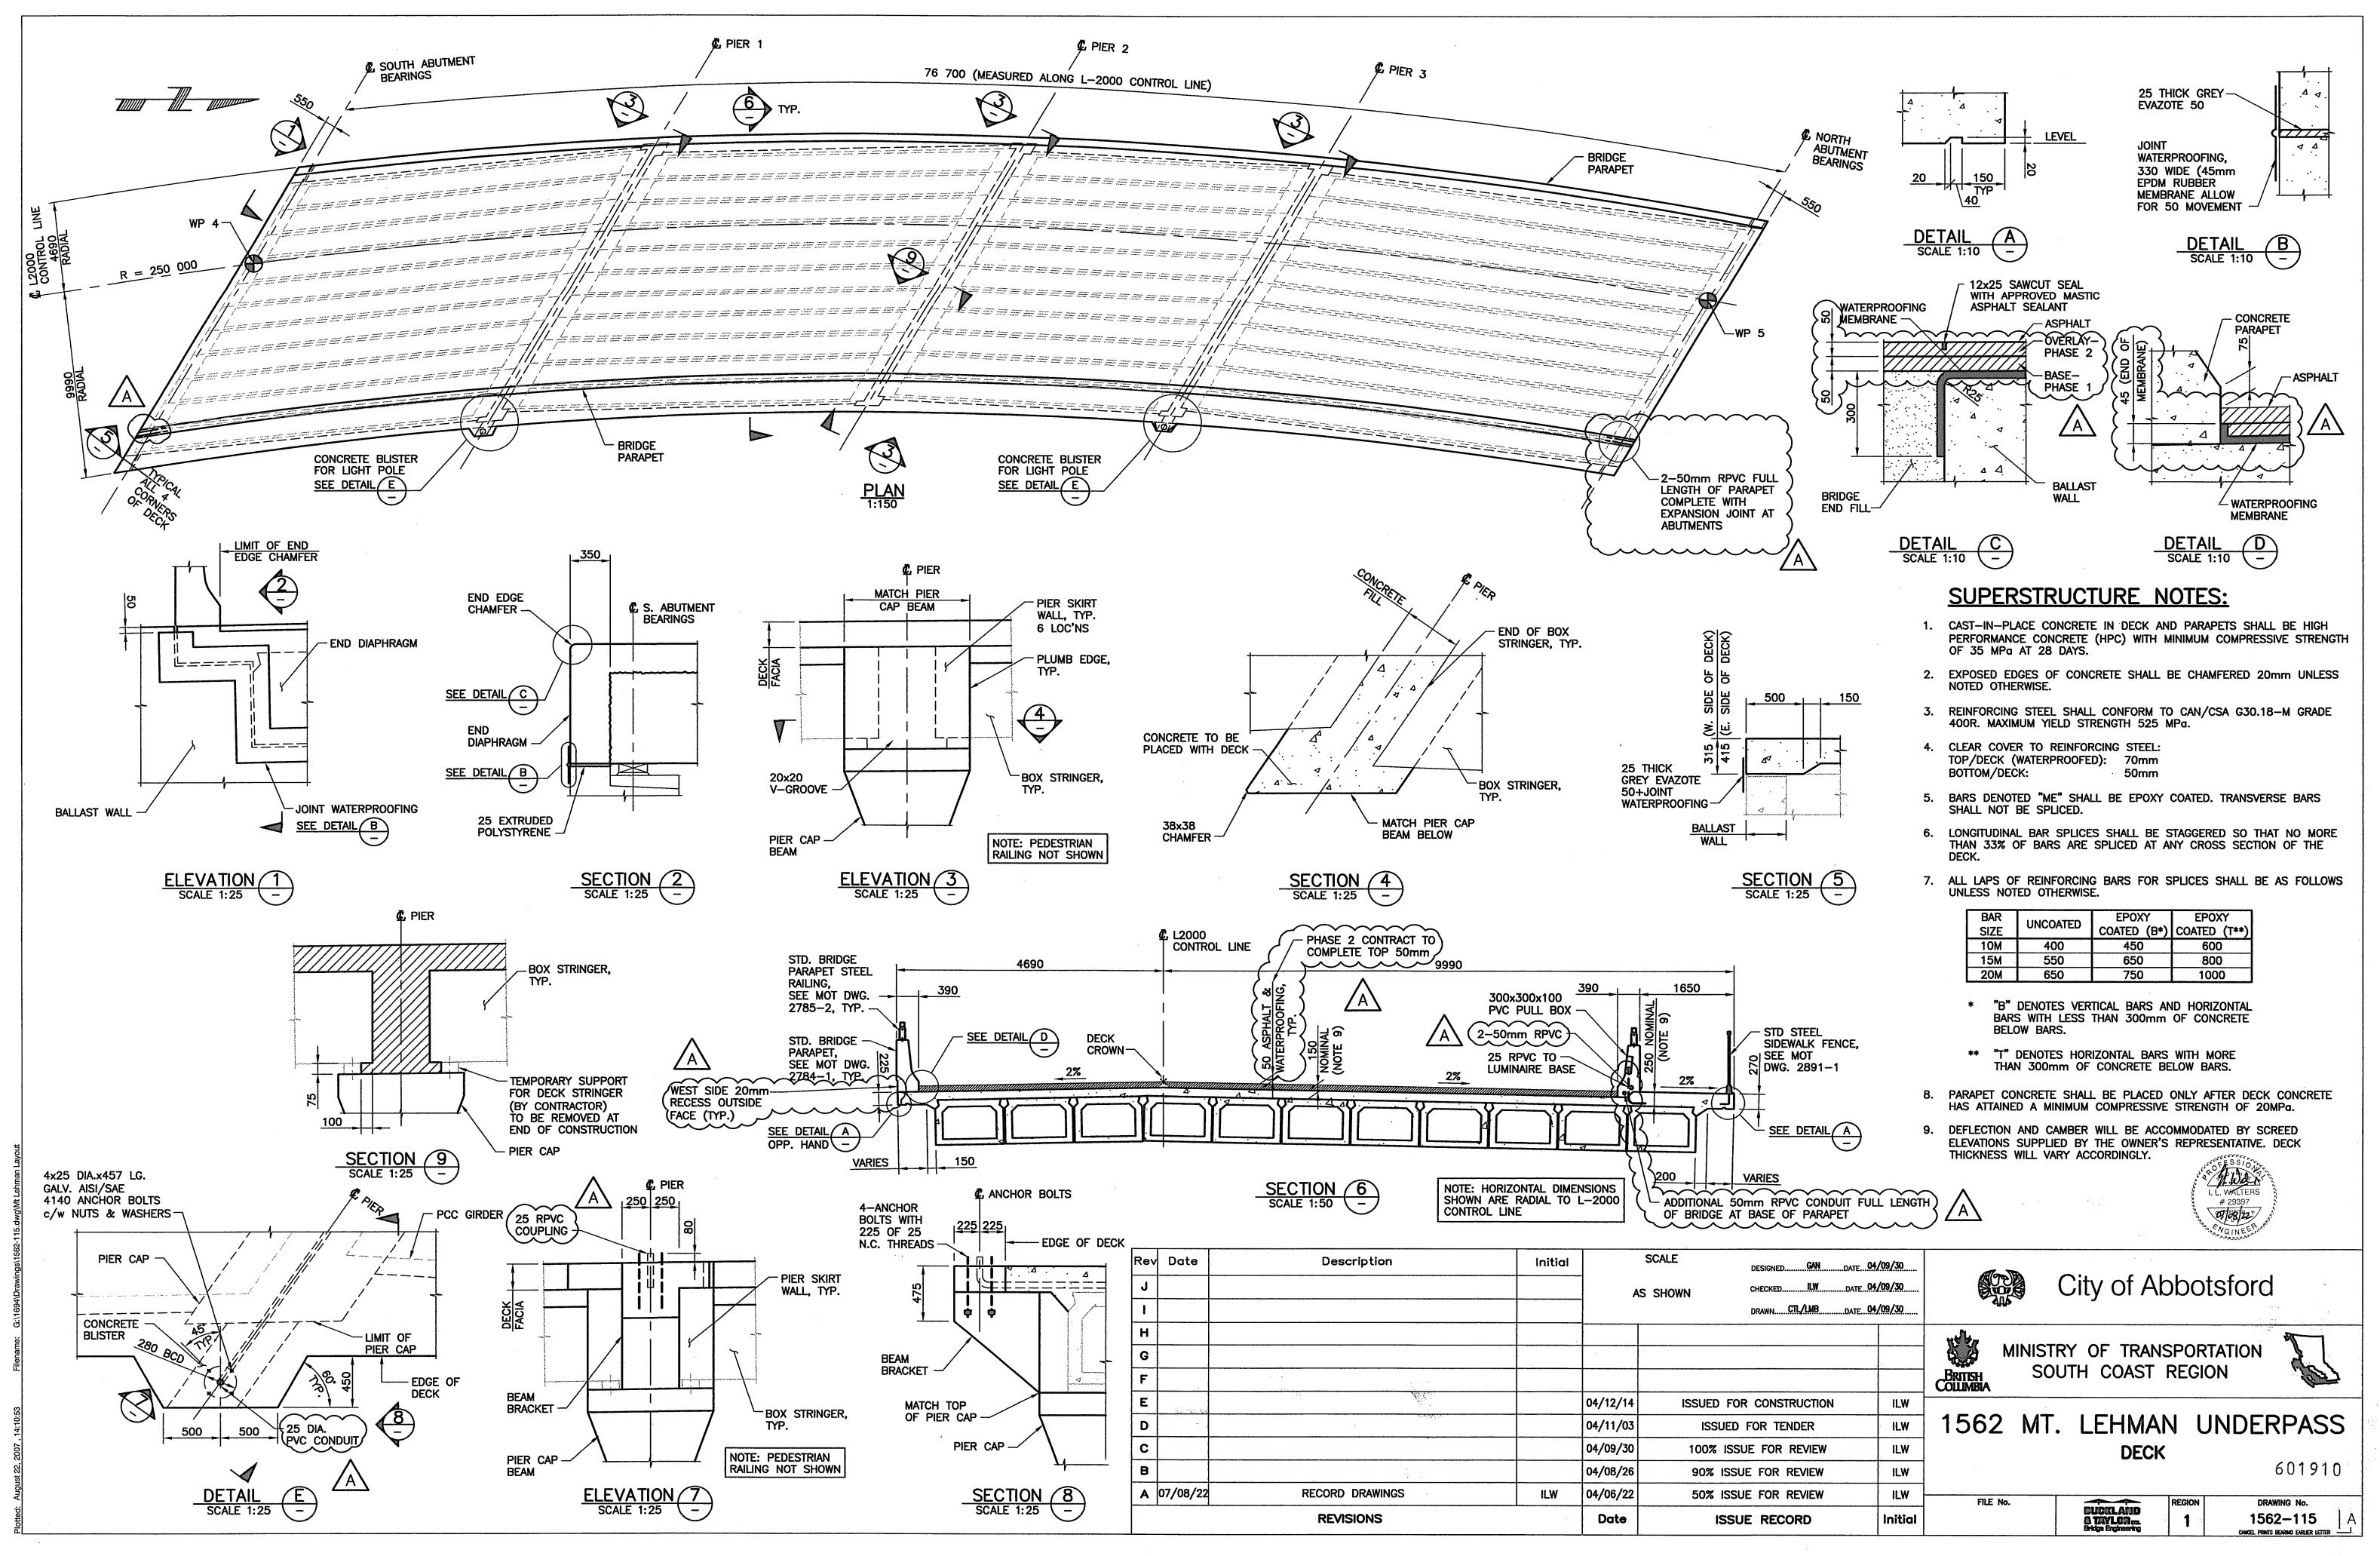
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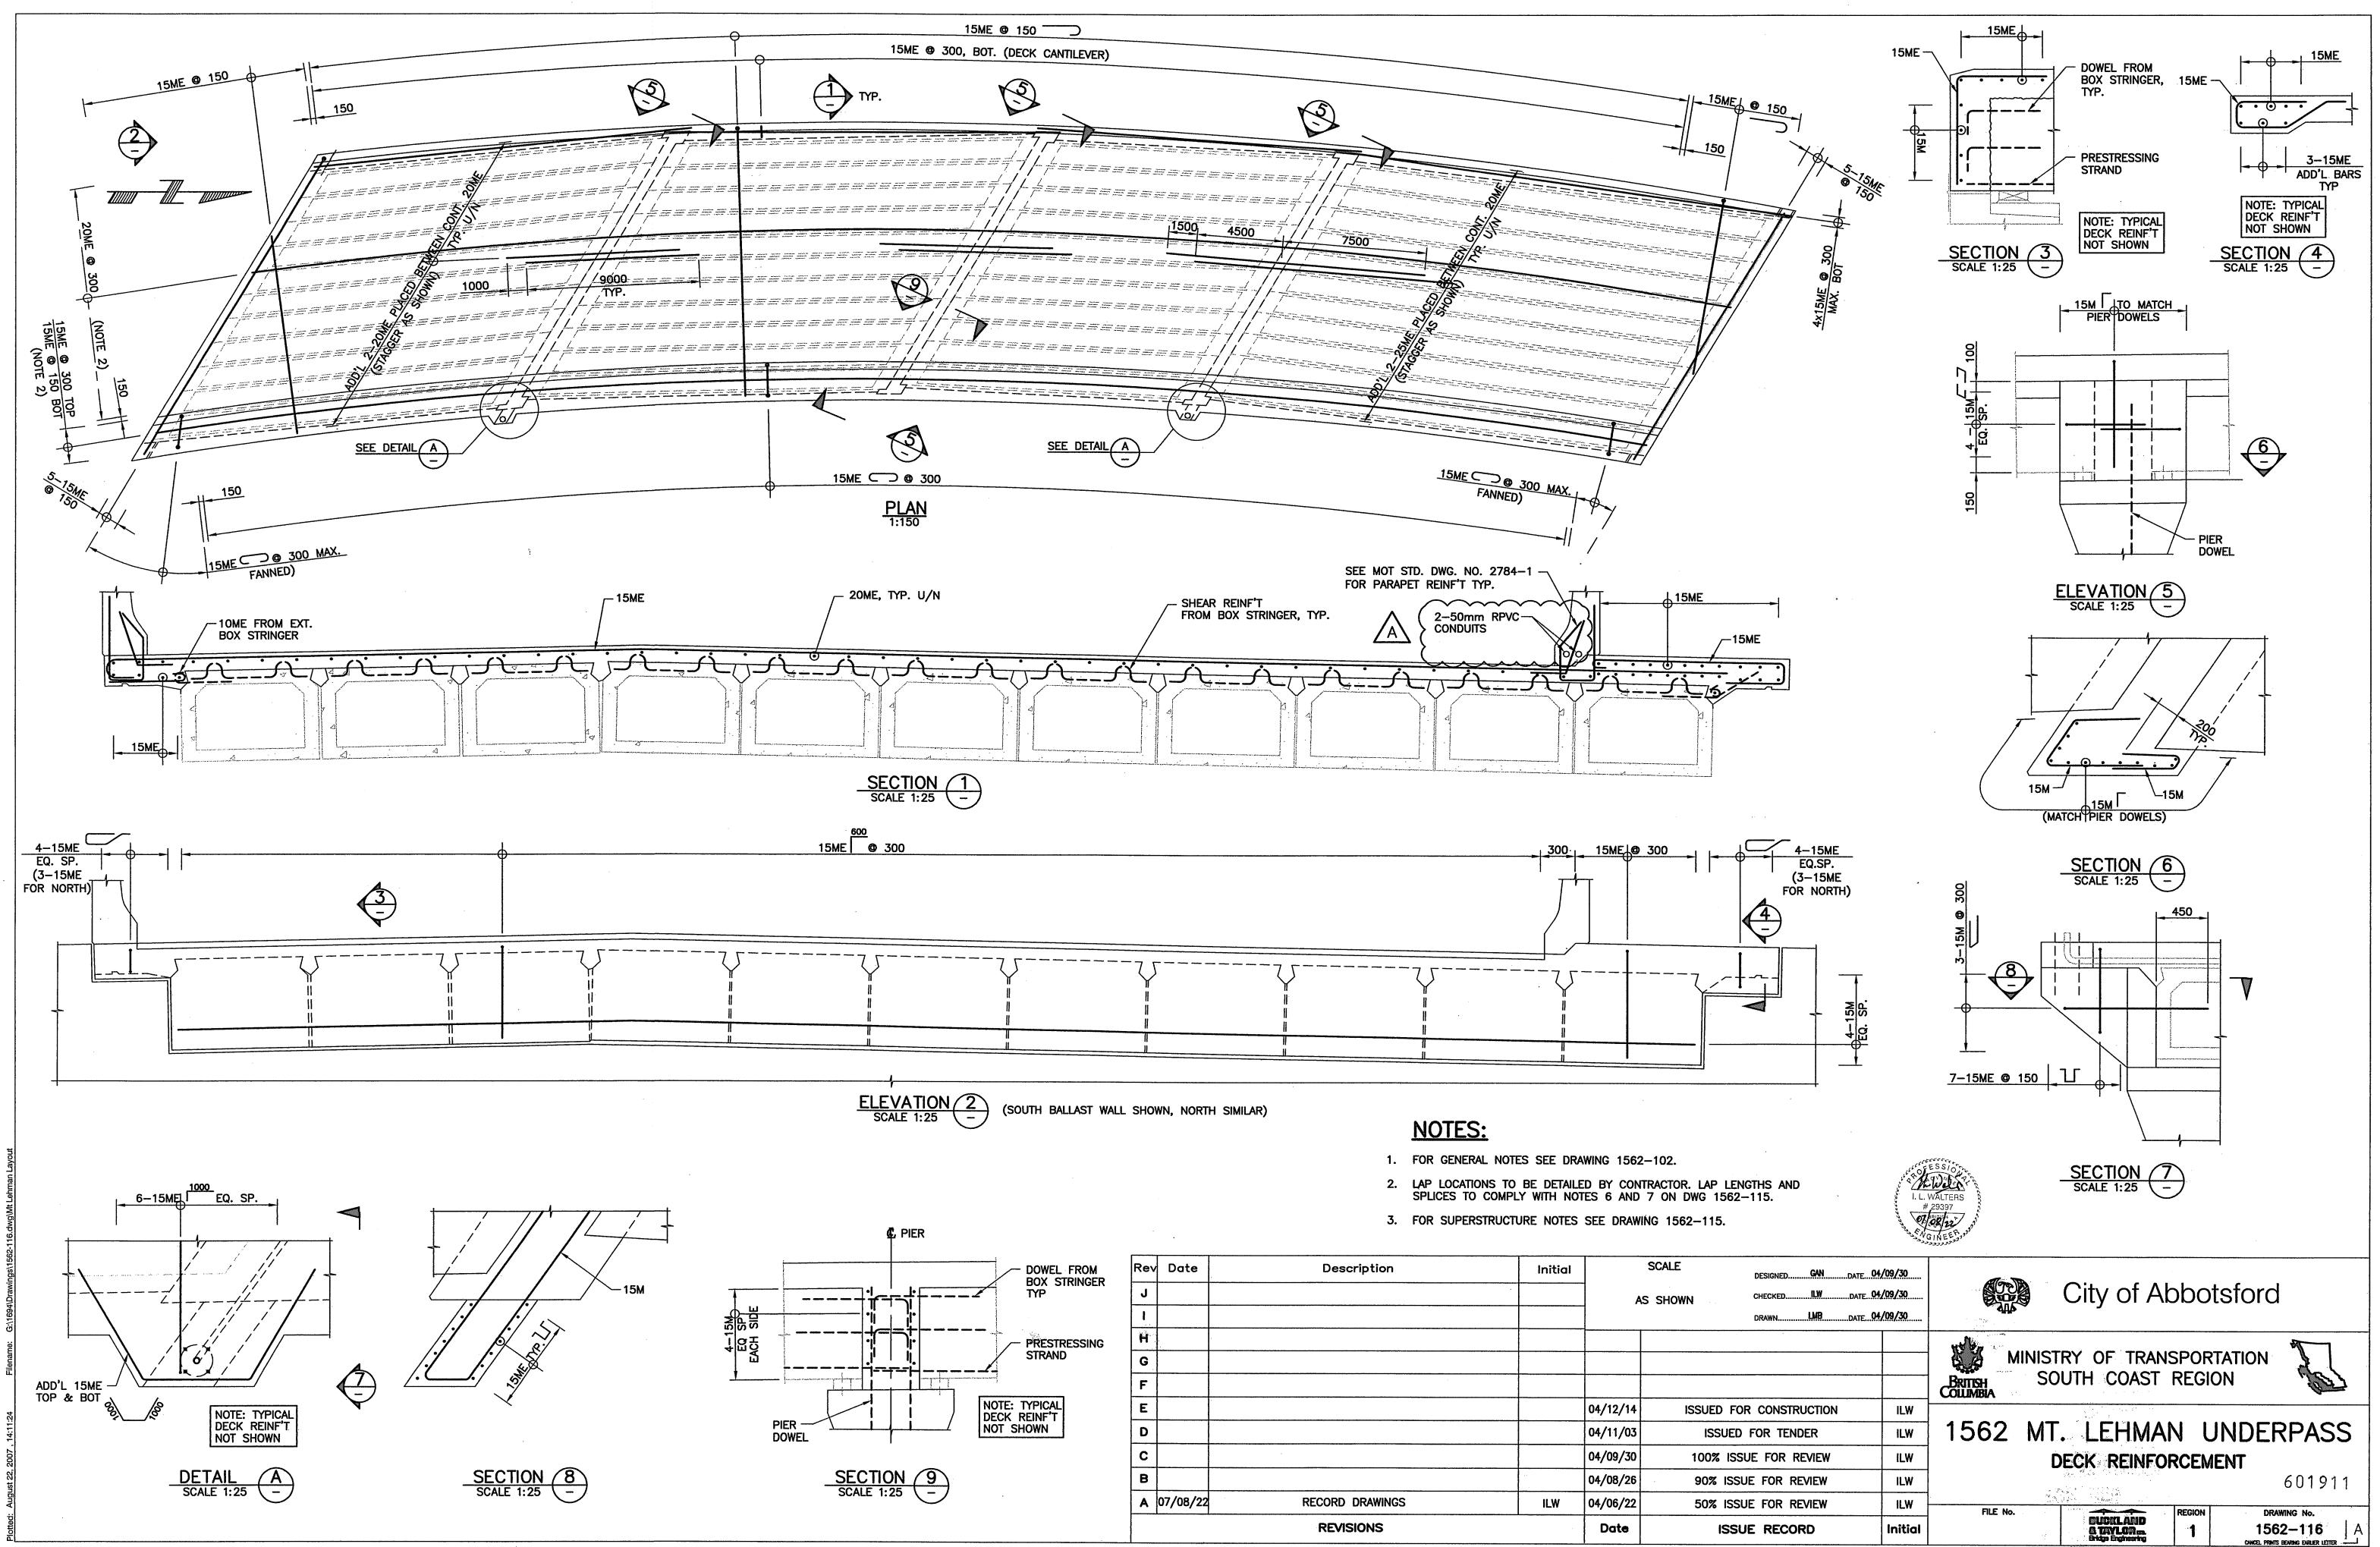


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A	07/08/22	RECORD DRAWINGS	ILW	04/09/30	100% ISSUE
	<u></u>	REVISIONS		Date	ISSUE

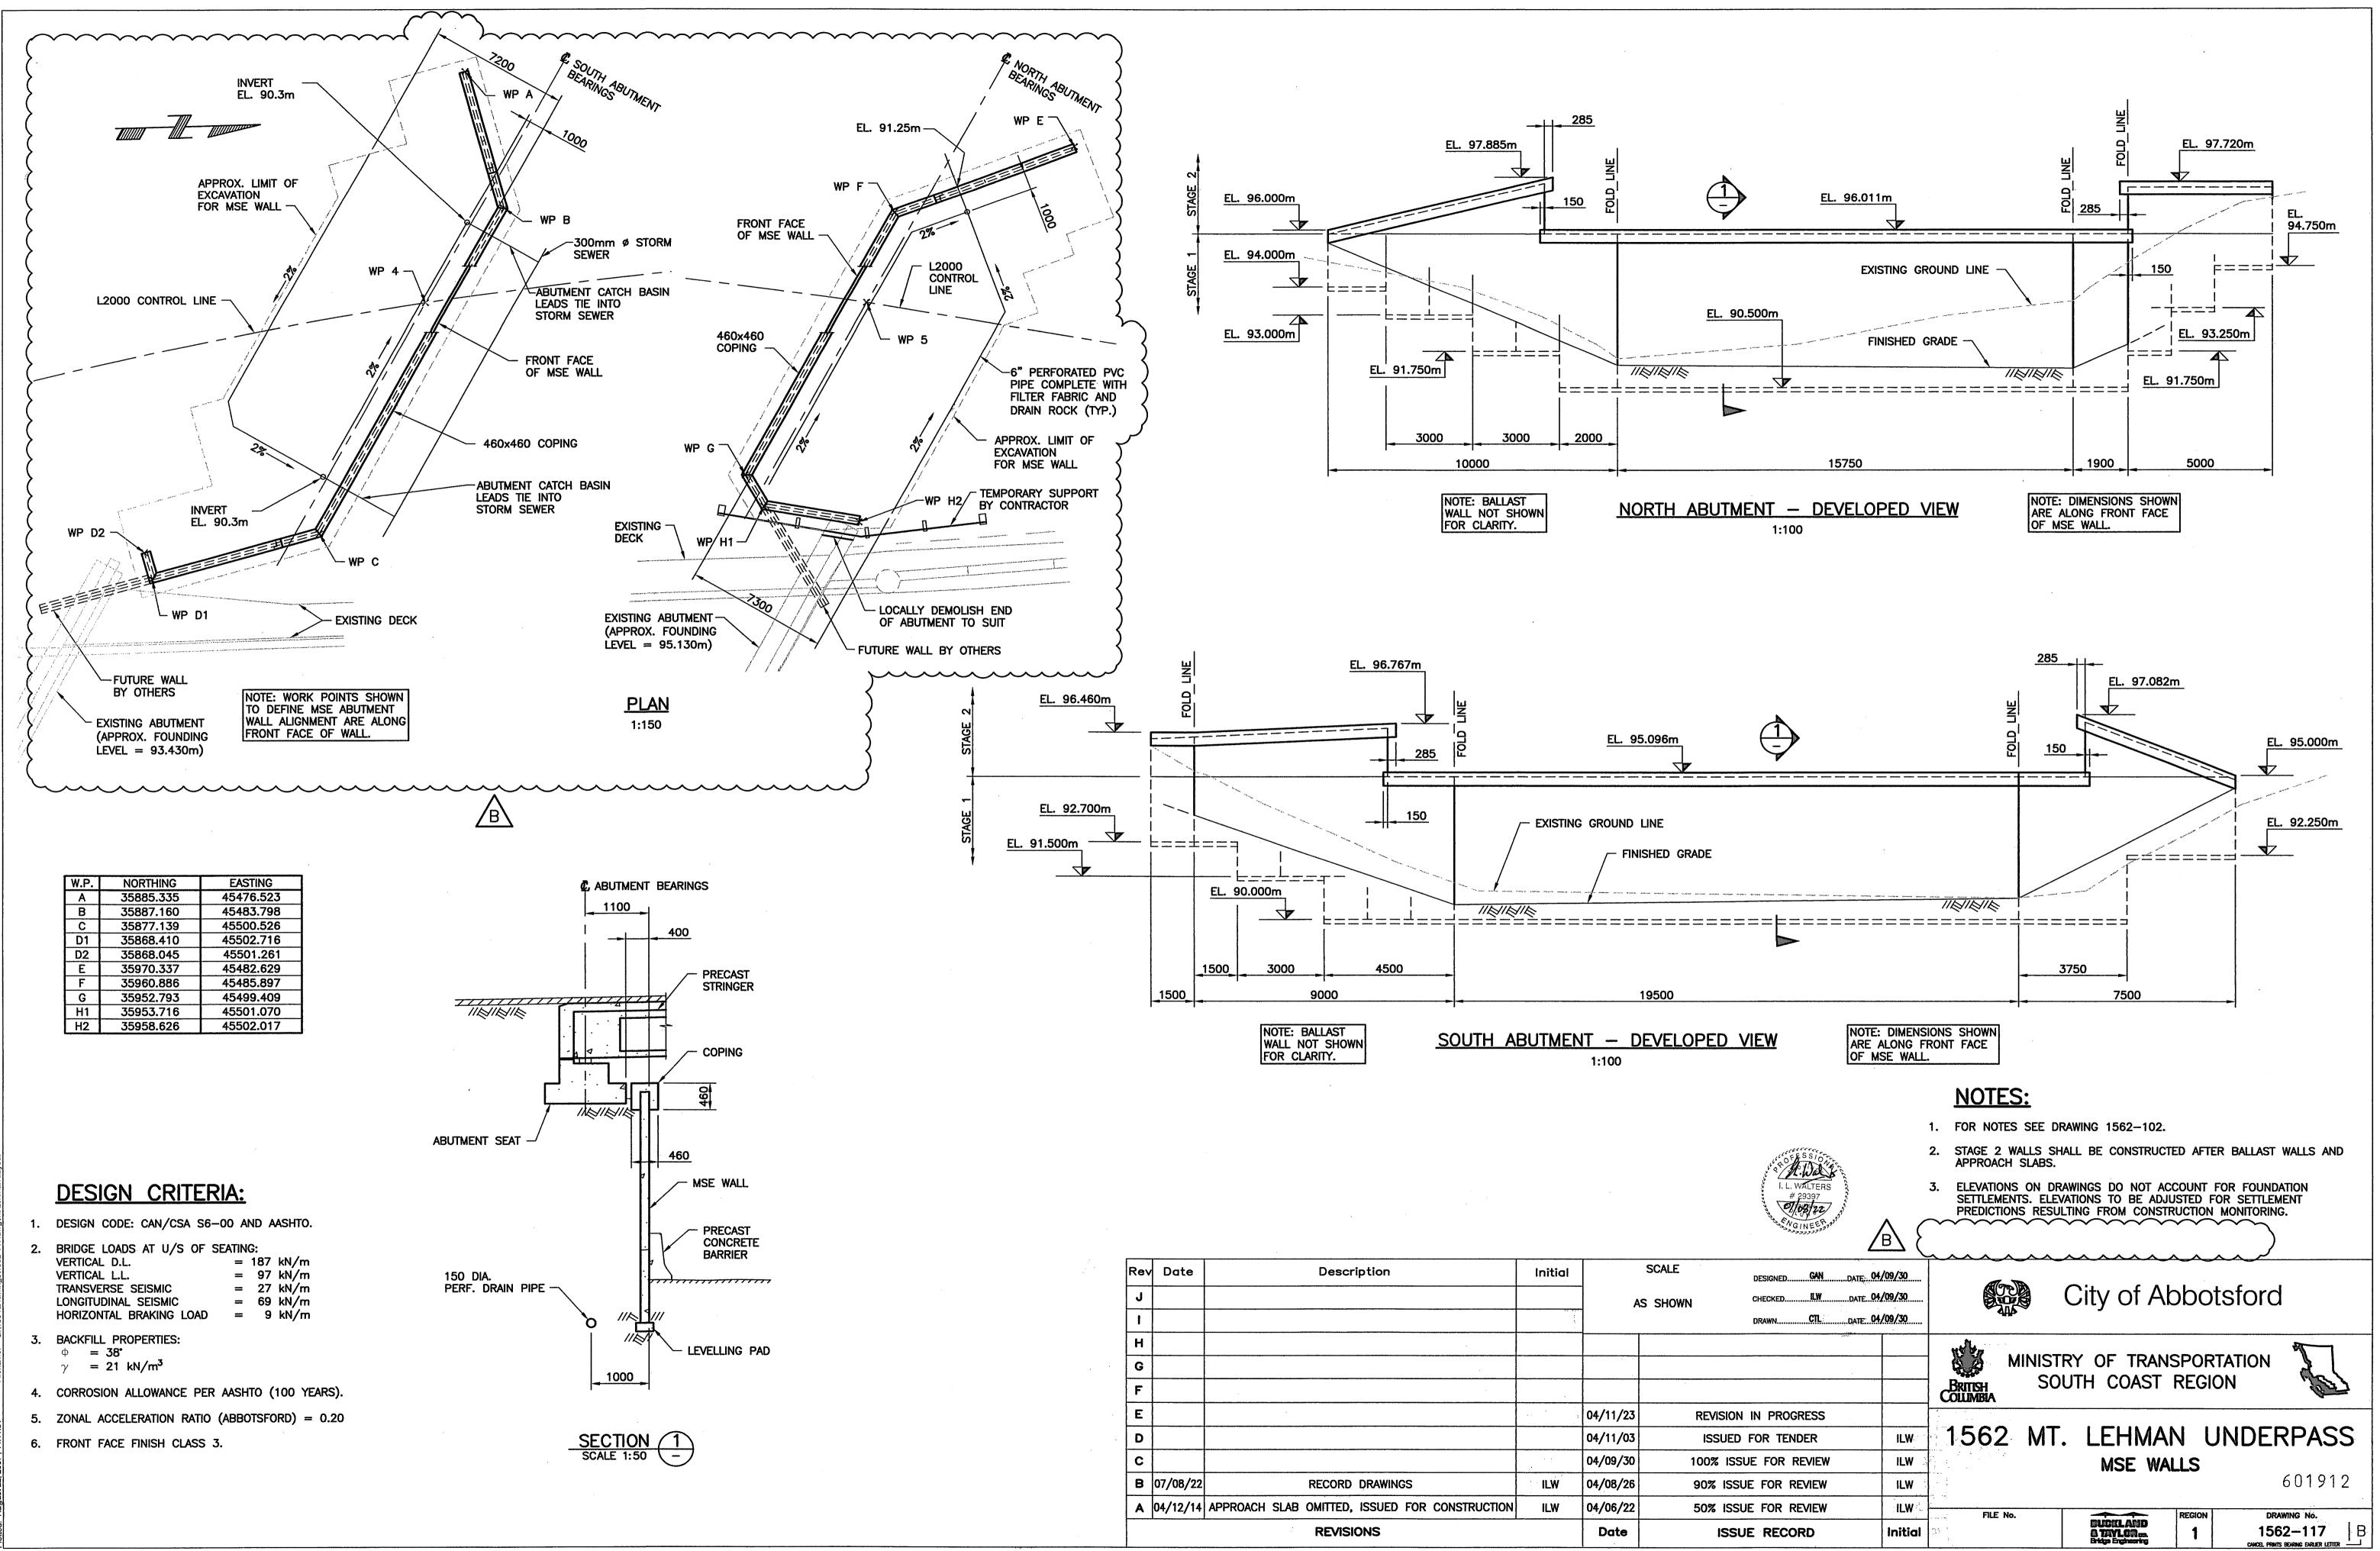


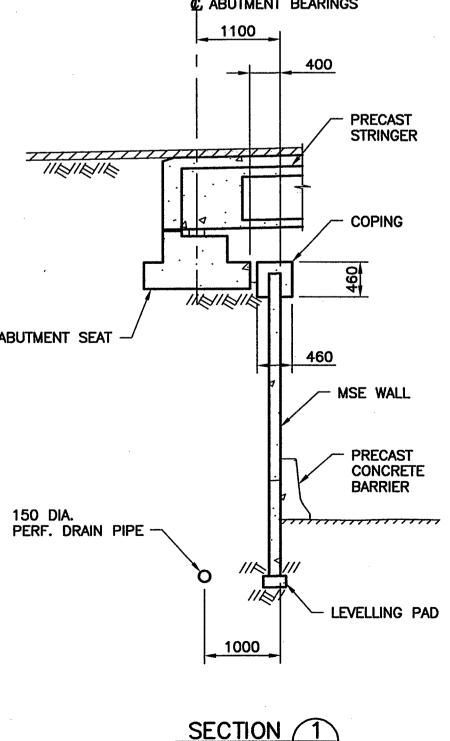
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D				04/11/03	ISSUED
С				04/09/30	100% ISS
В	07/08/22	RECORD DRAWINGS	ILW	04/08/26	90% ISSU
A	04/12/14	APPROACH SLAB OMITTED, ISSUED FOR CONSTRUCTION	ILW	04/06/22	50% ISSL
		REVISIONS		Date	ISSU