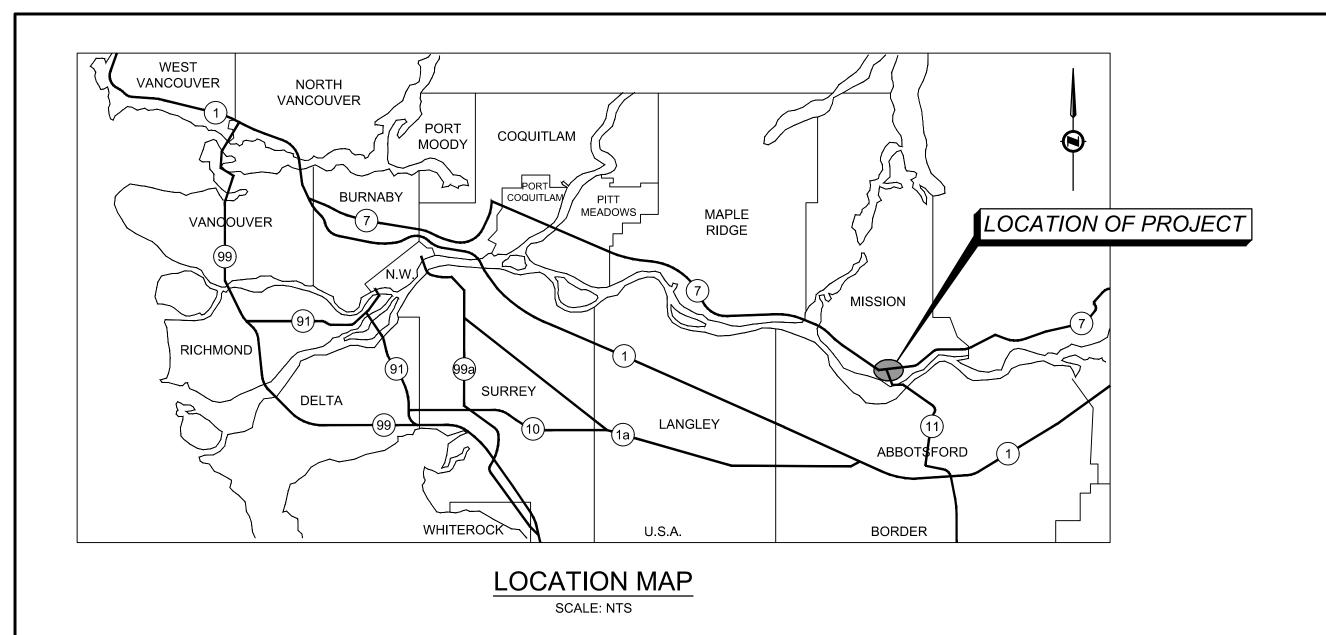


# BRITISH COLUMBIA Ministry of Transportation and Infrastructure

PROJECT NO. 12736-0001

## HIGHWAY 7 AND HIGHWAY 11 INTERSECTION IMPROVEMENTS



## Ministry of Transportation and Infrastructure BRITISH COLUMBIA

PROJECT NO. 12736-0001

## HIGHWAY No. 7 AND HIGHWAY No. 11 INTERSECTION IMPROVEMENTS

STA. POT 100+050.000 TO STA. POT 100+355.000

0.305 km

LANDMARK KILOMETRE INVENTORY HIGHWAY No. 7 SEGMENT 2724

km 28.26 to km 28.56

#### DRAWING INDEX

TE-90064-3

These drawings accurately record all significant design changes as provided to me by the Ministry

Representative and the design as represented by these Record Drawings substantially conforms with

the design intent and sound engineering practice.

ENGINEER OF RECORD

I have provided the EOR with records of all significant

design changes known to me, having exercised due diligence in monitoring the construction of the work.

SIGNATURE

MINISTRY REPRESENTATIVE

LOCATION MAP, KEY PLAN, DRAWING INDEX, CONTROL POINT TABLE

R1-862-002 R1-862-101 AND 102 R1-862-201 AND 202 PROFILES

R1-862-301 TYPICAL SECTIONS AND DETAILS

**GEOMETRICS & LANING** R1-862-401 AND 402

R1-862-601 AND 602 SIGNING AND PAVEMENT MARKINGS

TE-17023-1 SIGNAL AND LIGHTING MODIFICATION: SITE PLAN - NOTES - ELEVATIONS - LEGEND TE-17023-2 SIGNAL AND LIGHTING MODIFICATION: SITE PLAN ENLARGEMENT - COLOUR CODE

SIGNAL AND LIGHTING MODIFICATION: SIGNAL DISPLAY - ELEVATIONS - DETECTOR LOOP TABLE TE-17023-3

SIGNAL AND LIGHTING MODIFICATION: SITE PLAN - ELEVATIONS

## LOGAN AVE FLETCHER AVE LOUGHEED HWY No 7 TO AGASSIZ TO MAPLE RIDGE OUGHEED HWY No 7 LIMIT OF CONSTRUCTION POT 100+355.000 LIMIT OF CONSTRUCTION POT 100+050.000

**KEY PLAN** 

SCALE: NTS

#### PROJECT CONTROL POINTS TABLE

LOCAL GROUND COORDINATES									
	N GROUND	E GROUND	ELEV	N UTM	E UTM				
897056	443949.119	551081.821	8.324	5441953.367	550879.794				
G01	444015.279	549449.946	10.840	5442019.503	549248.518				
G02	444126.134	549401.907	15.440	5442130.317	549200.496				
G03	444469.357	549365.242	18.520	5442473.414	549163.845				
RP01	443996.326	549496.220	9.485	5442000.557	549294.775				
RP02	444017.227	549531.109	7.912	5442021.450	549329.651				
RP03	444258.194	549386.745	16.761	5442262.329	549185.340				
RP04	444395.322	549376.915	17.311	5442399.406	549175.513				
DH01	444200.601	549392.231	16.545	5442204.757	549190.824				
DH02	444338.975	549366.566	17.464	5442343.080	549165.168				
DH03	444412.460	549357.633	18.111	5442416.538	549156.238				

PRIMARY CONTROL COORDINATES AND ELEVATIONS ARE DERIVED FROM GEODETIC CONTROL MONUMENT 897056 AND ARE PROVIDED BY MOTI.

ALL COORDINATES ARE LOCAL, BASED ON NAD83(CSRS) DATUM WITH ELEVATIONS CALCULATED USING THE HT2.0 GEOID MODEL. AVERAGE COMBINED SCALE FACTOR: 0.9996334000. TACK POINT 0,0. GRID SHIFT -5000000m IN NORTHING.

UTILITIES DRAWN FROM FIELD LOCATES AND B.C.ONE CALL. UTILITIES OTHER THAN THOSE REPRESENTED IN THESE DRAWINGS MAY EXIST.

R1-862-001

### LEGEND

EXISTING (SYMBOLS)		EXISTING (LINETYPES)			
SURVEY		ALIGNMENT			
REFERENCE POINT	Δ	BROKEN WHITE LINE - URBAN — — <u>3</u> 6 <u>3</u> — — —	_		
WITNESS POST	<b>™</b> WT	BROKEN WHITE LINE - DECEL — — — <u>3</u> 3 <u>3</u> — — — —			
		DOUBLE YELLOW LINE — DY/L — DY/L			
AERIAL UTILITIES		SHOULDER			
POWER / TELEPHONE POLE	<del></del>	YELLOW LINE ————————————————————————————————————			
POWER POLE					
POWER / TELEPHONE POLE WITH TRANSFORMER	<del>-</del>	BARRIERS			
		CONCRETE ROADSIDE / MEDIAN BARRIER			
DRAINAGE					
CULVERT	$\dashv$	CONSTRUCTION			
CULVERT INLET	CI	RIPRAP — — — — — — — — —			
CULVERT OUTLET	— co				
MANHOLE		FEATURES			
CATCH BASIN	<i>1111</i> 2	FENCEX			
HEADWALL					
		UNDERGROUND			
ELECTRICAL		STORM / SEWER DRAIN ————————————————————————————————————			
LAMP STANDARD	OLS	UNDERGROUND ELECTRICAL POWER — UE — — — —			
TRAFFIC SIGNAL / CAMERA	<b>&gt;</b>	PIPELINE (NOT PLASTIC) — — — — — — — — — — — — — —			
JUNCTION BOX	□ JB				
		HYDROLOGY			
METERS		DITCH, CREEK OR STREAM CENTER ————————————————————————————————————			
WATER VALVE	$_{igotimes}$ WV	DITCH EDGE — — — — — — — — — — — —			
FIRE HYDRANT	⊗FH				
		LOT BOUNDARIES			
ROAD SIGNS		PROPERTY LINE ————————————————————————————————————			
ONE POST (WOOD / PERFORATED SQUARE STEEL / ROUND STEEL)	þ	DISTRICT LOT BOUNDARY ————————————————————————————————————			
TWO POST (WOOD / PERFORATED SQUARE STEEL)	_	TO DO OD A DUNA			
OVERHEAD SIGN		TOPOGRAPHY			
OVERHEAD MESSAGE BOARD		BASE OF SLOPE OR EMBANKMENT			
		TOP OF SLOPE OR EMBANKMENT			
		WALL BIN WALL, HEAD WALL,			
		RETAINING WALL, WING WALL			

#### PROPOSED (SYMBOLS)

**ROAD SIGNS** 

ONE POST (WOOD / PERFORATED SQUARE STEEL / ROUND STEEL)

#### PROPOSED (LINETYPES)

ALIGNMENT

RAISED MEDIAN

CONTROL LINE BROKEN WHITE LINE - URBAN BROKEN WHITE LINE - DECEL SOLID WHITE LINE EDGE OF PAVEMENT HATCHING 50 mm MILL AND 50 mm OVERLAY

I have provided the EOR with records of all significant design changes known to me, having exercised due diligence in monitoring the construction of the work.

These drawings accurately record all significant design changes as provided to me by the Ministry Representative and the design as represented by these Record Drawings substantially conforms with the design intent and sound engineering practice.

SIGNATURE

MINISTRY REPRESENTATIVE

SIGNATURE ENGINEER OF RECORD



To Engineering	sc	ALE	CAD FILENAME _ PLOT DATE _	R1-862-000.DWG 3/1/2019
Engineering and Land Services	REV	DATE	REVISIONS	NAME
	Α	2019-03-01	RECORD DRAWING	A. SANTOS
SUITE 201, 8506 - 200 STREET LANGLEY, BRITISH COLUMBIA, V2Y 0M1	-	-	-	-
PH: 604.371.0091 FAX: 604.371.0098	-	-	-	-



MINISTRY OF TRANSPORTATION AND INFRASTRUCTURE

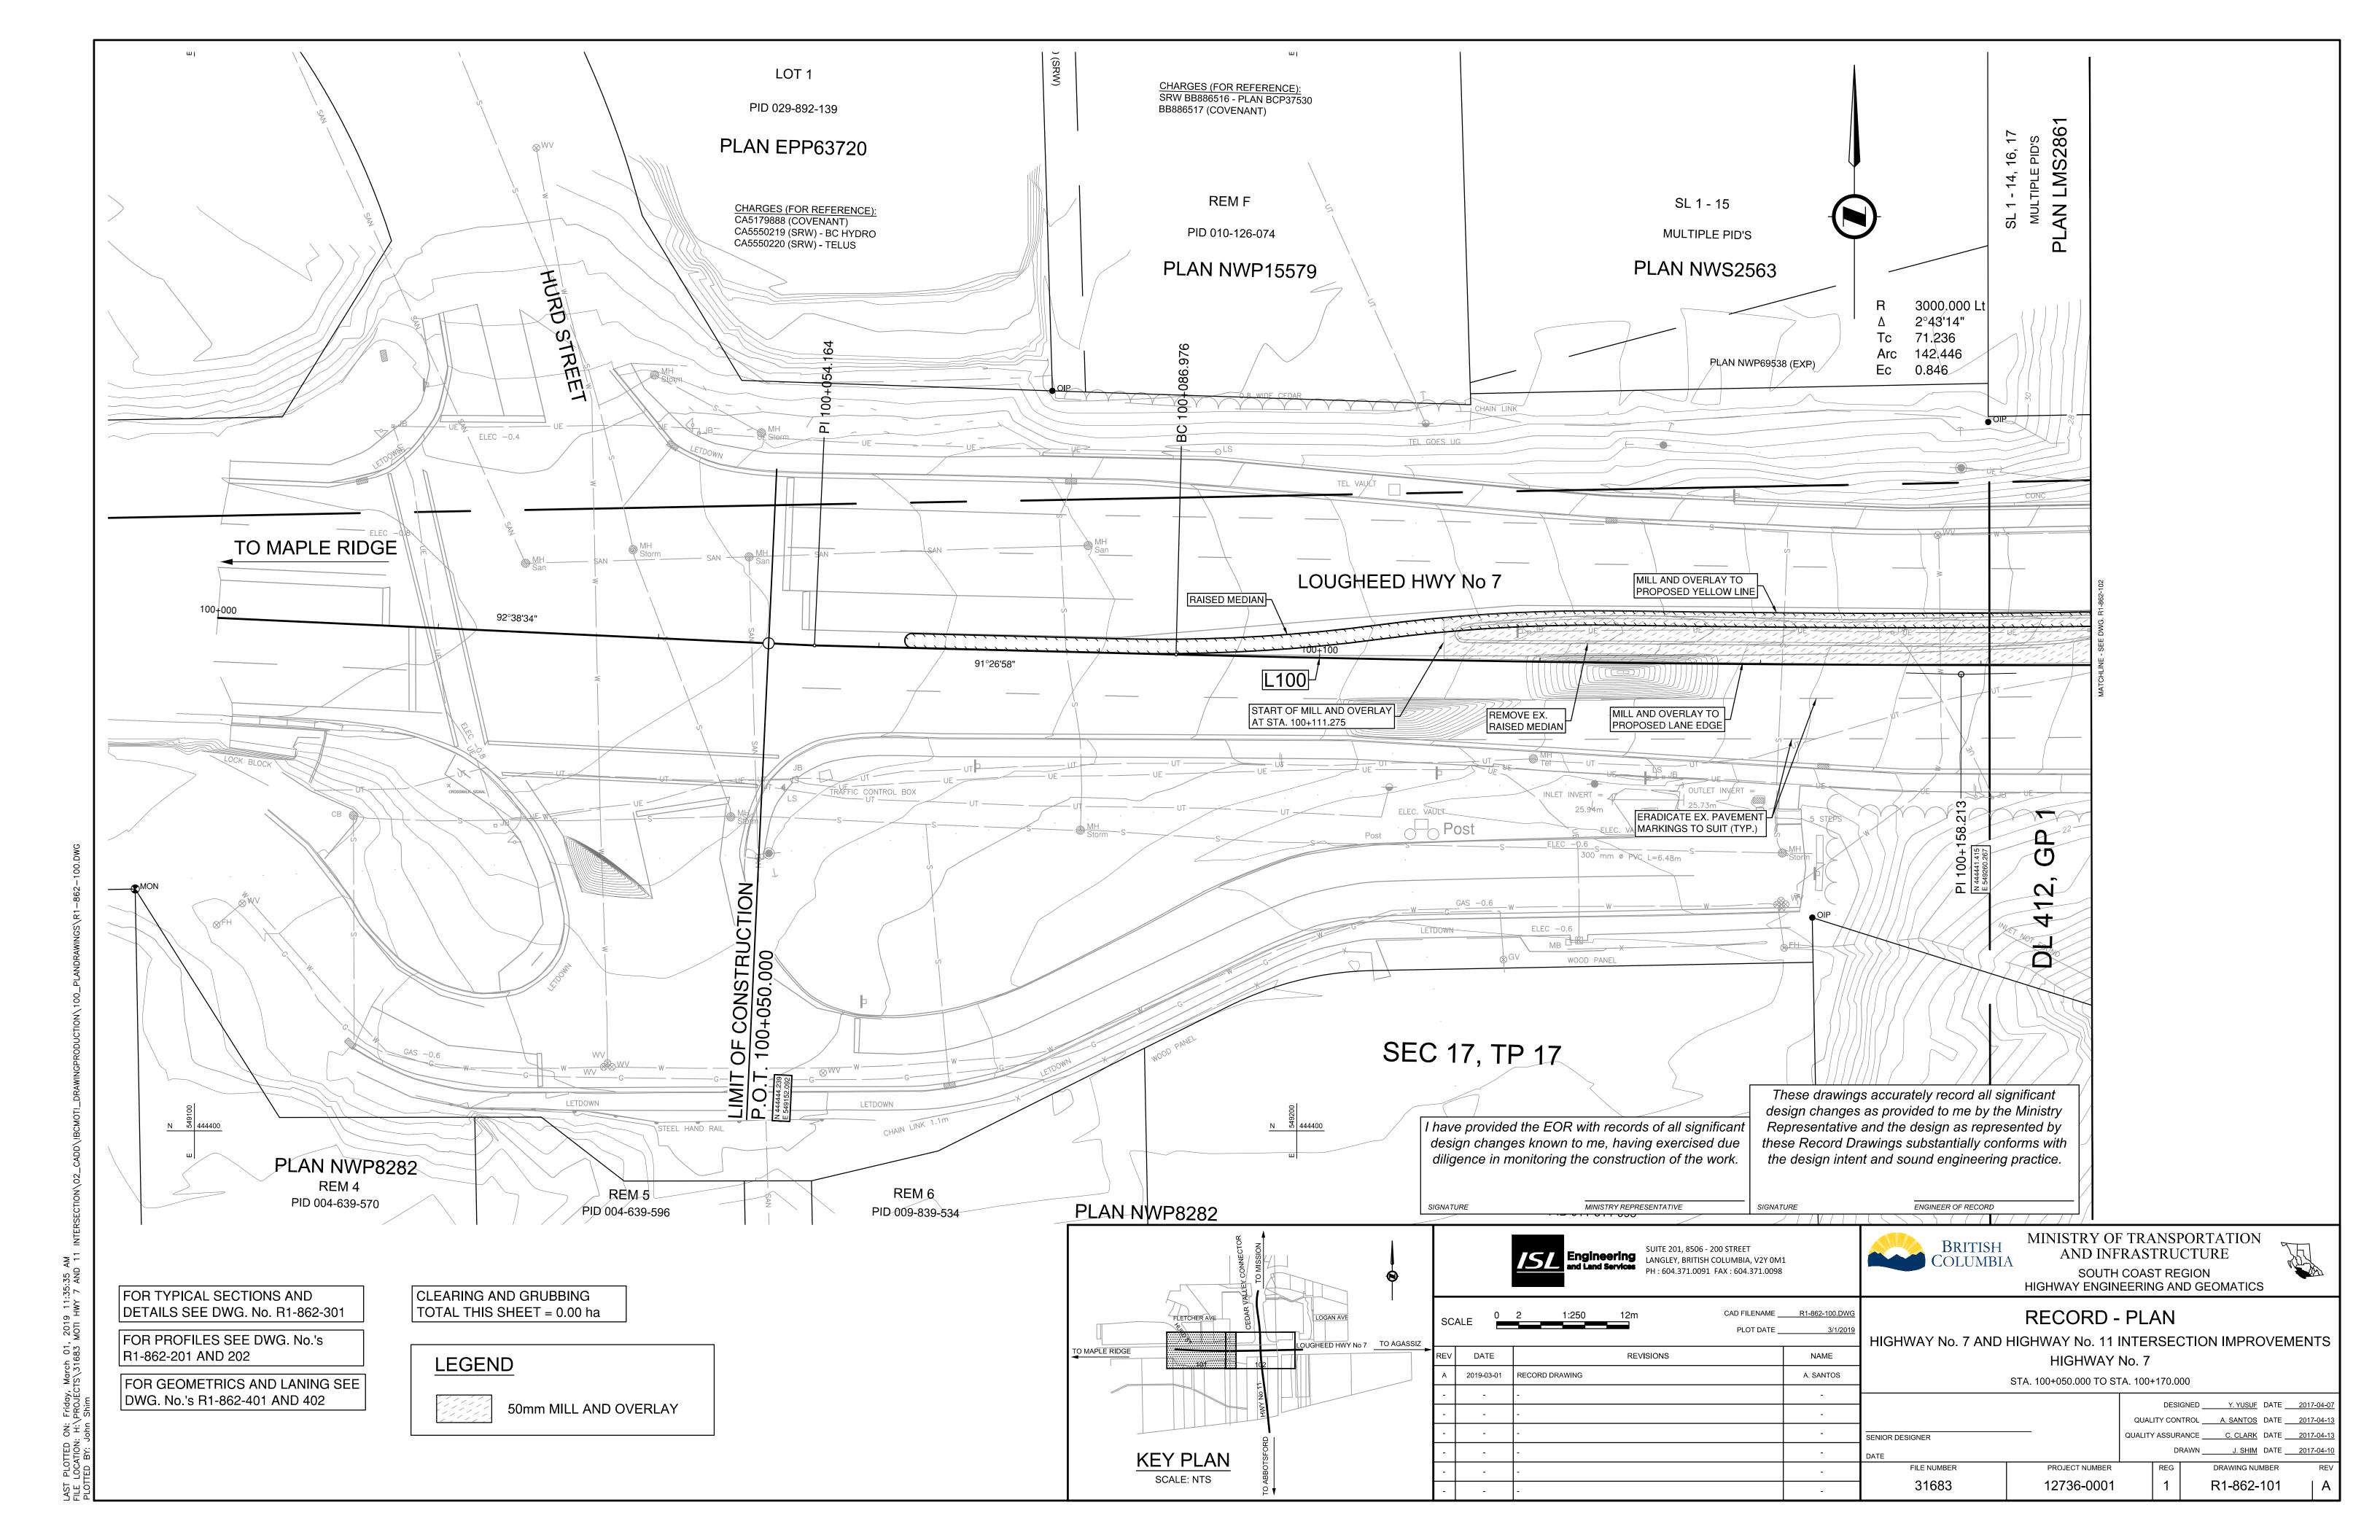
SOUTH COAST REGION HIGHWAY ENGINEERING AND GEOMATICS

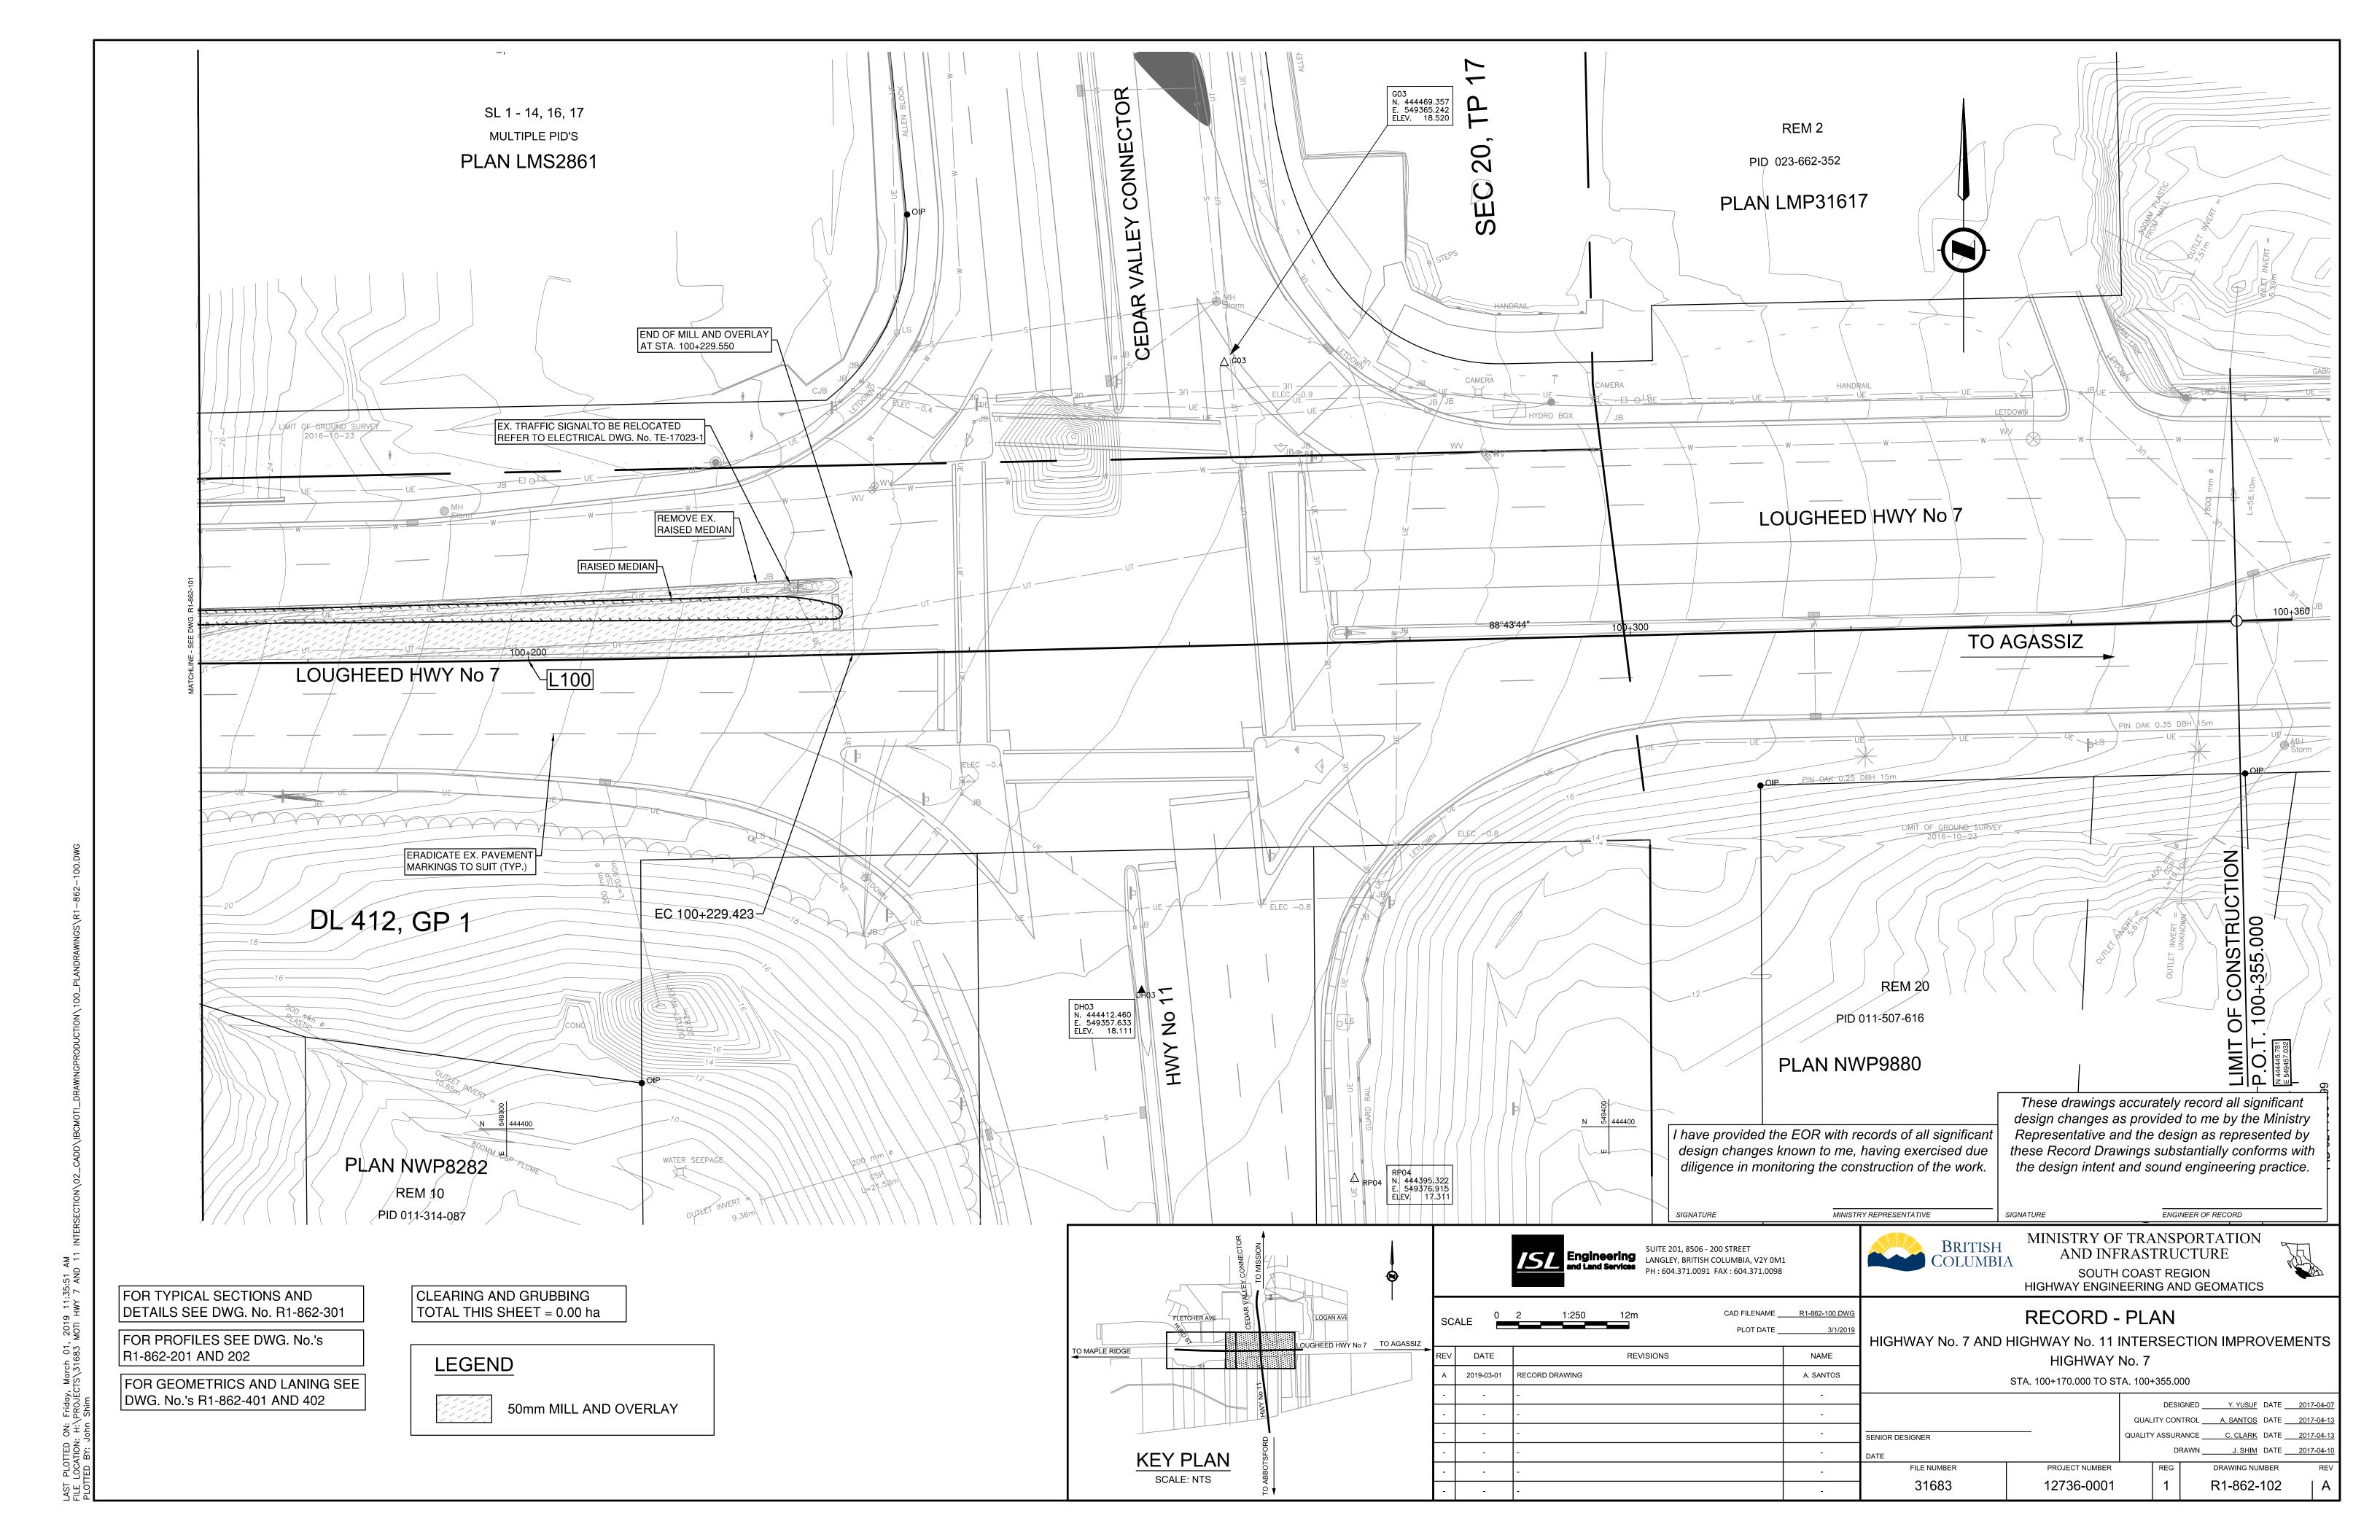
DESIGNED Y.YUSUF DATE 2017-04-07 QUALITY CONTROL A. SANTOS DATE 2017-04-13 QUALITY ASSURANCE \_\_\_\_\_\_C. CLARK DATE \_\_\_\_\_2017-04-13 DRAWN \_\_\_\_\_\_ J. SHIM DATE \_\_\_\_\_2017-04-10

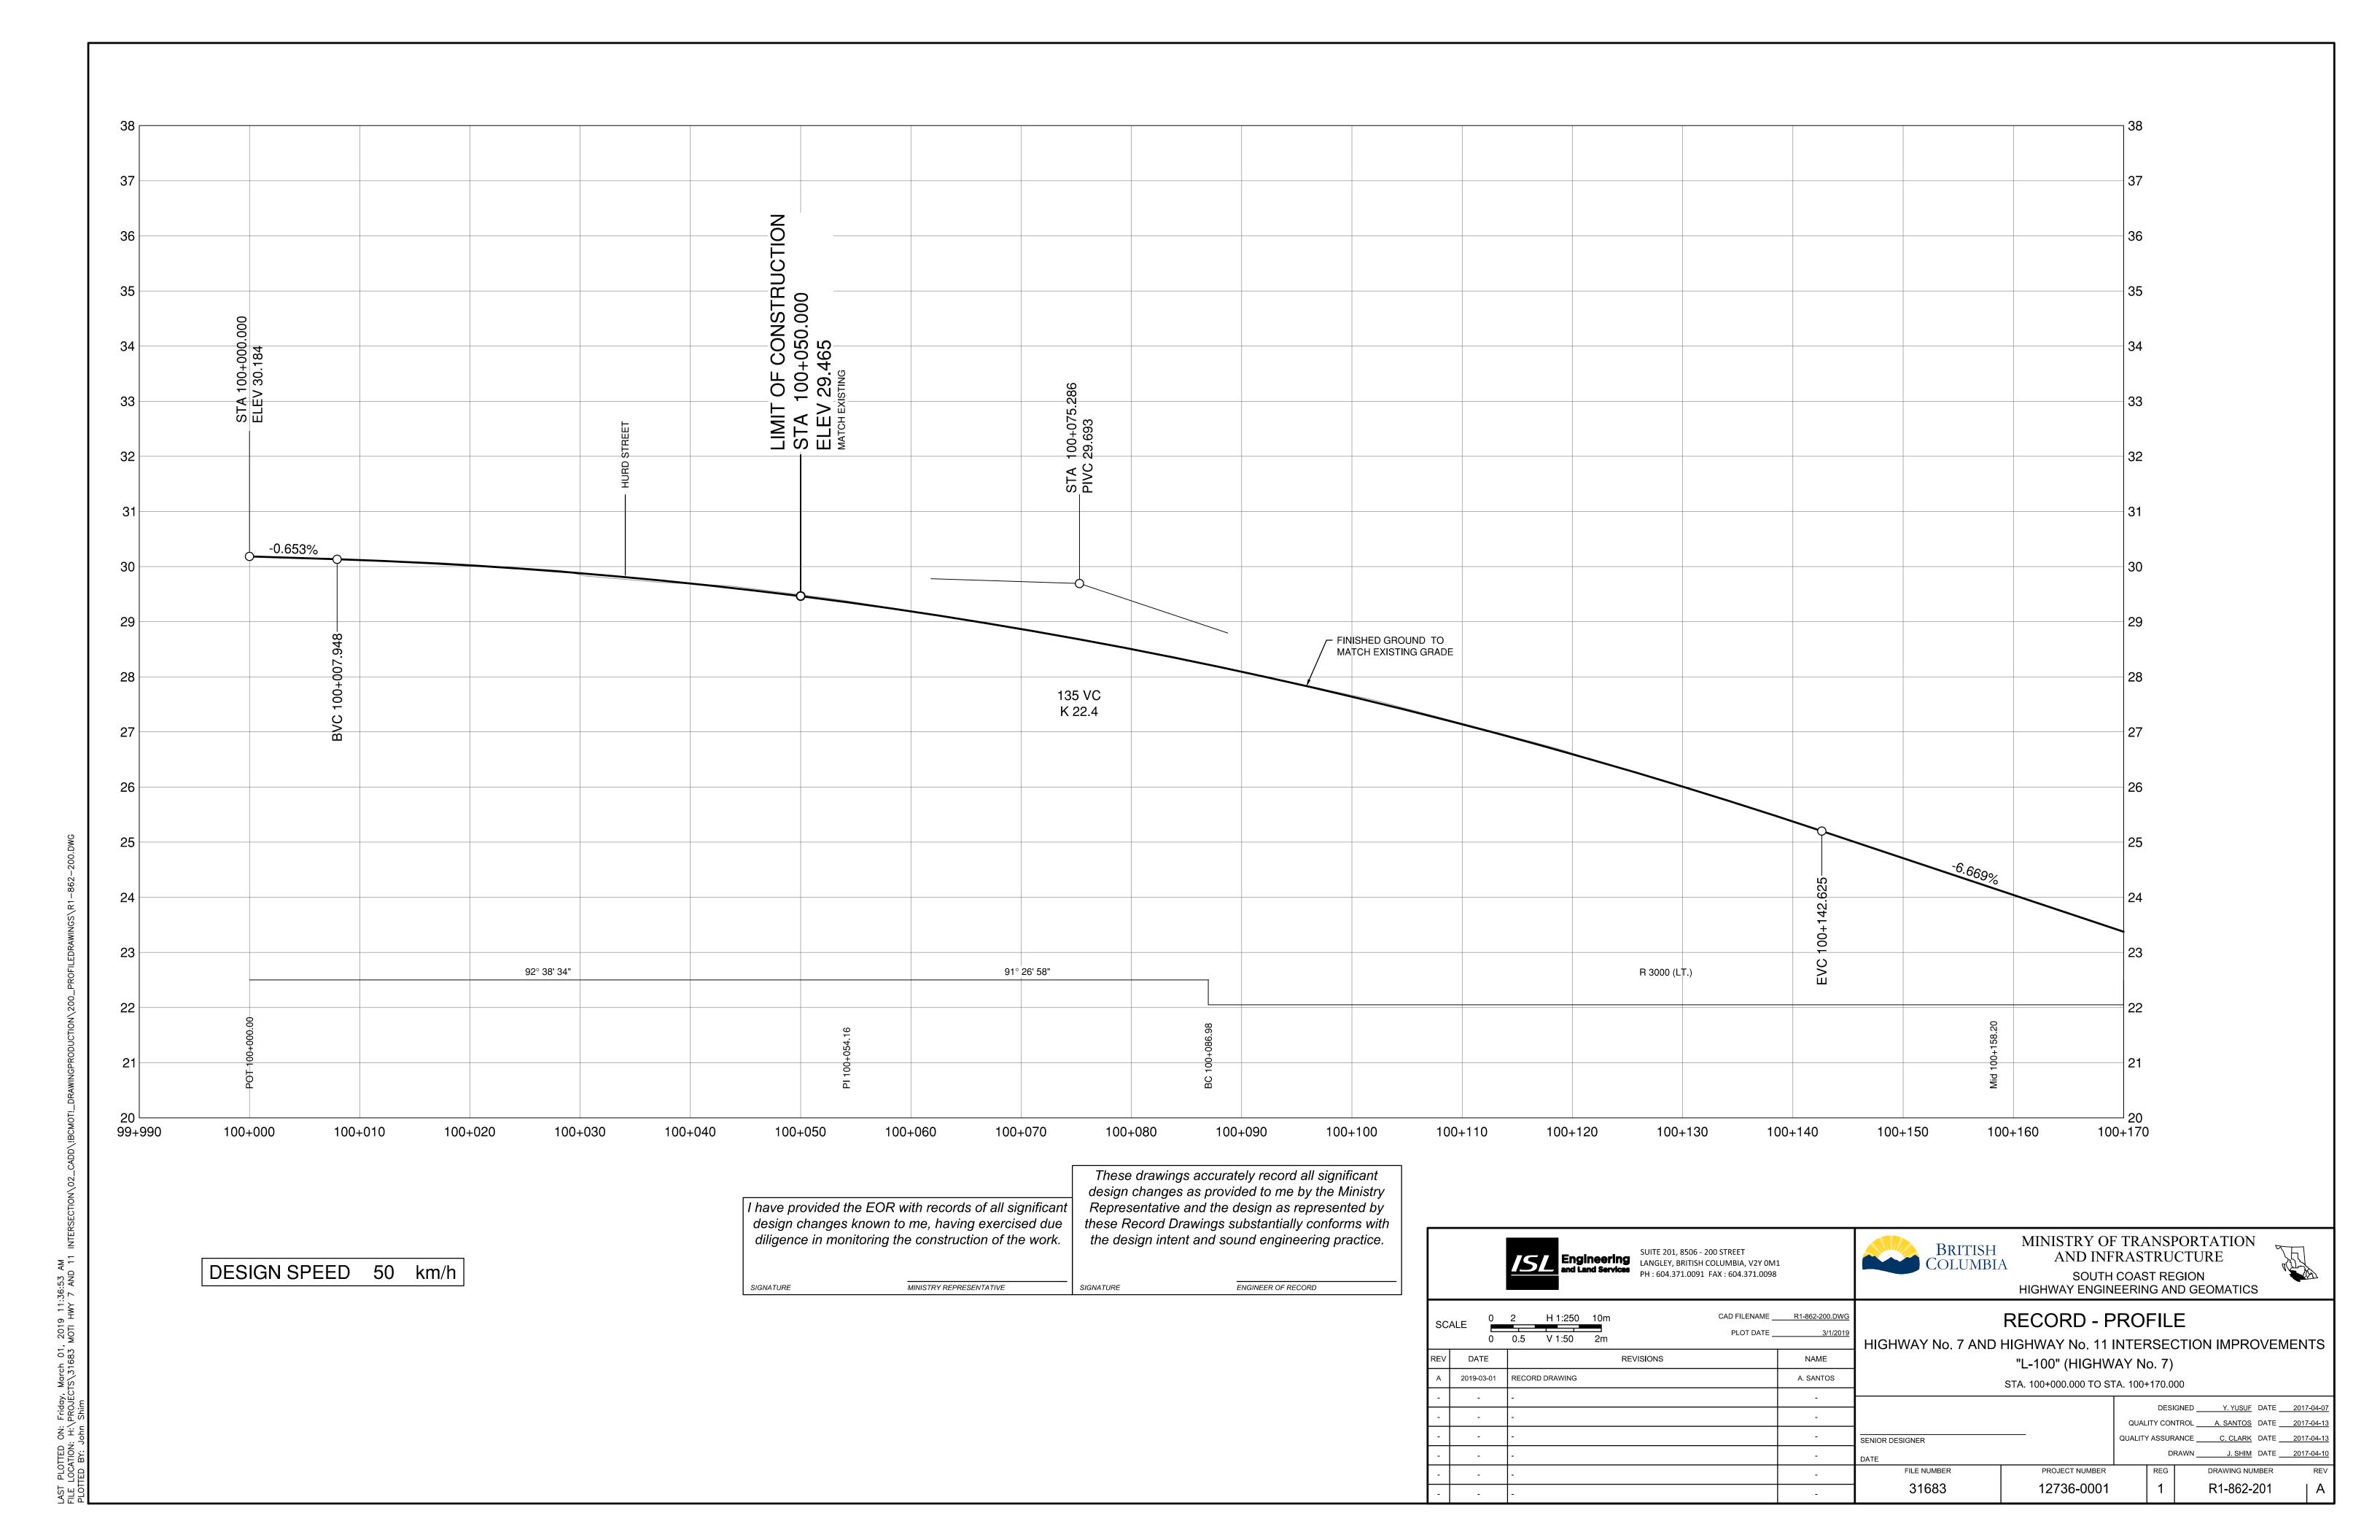
#### LEGEND

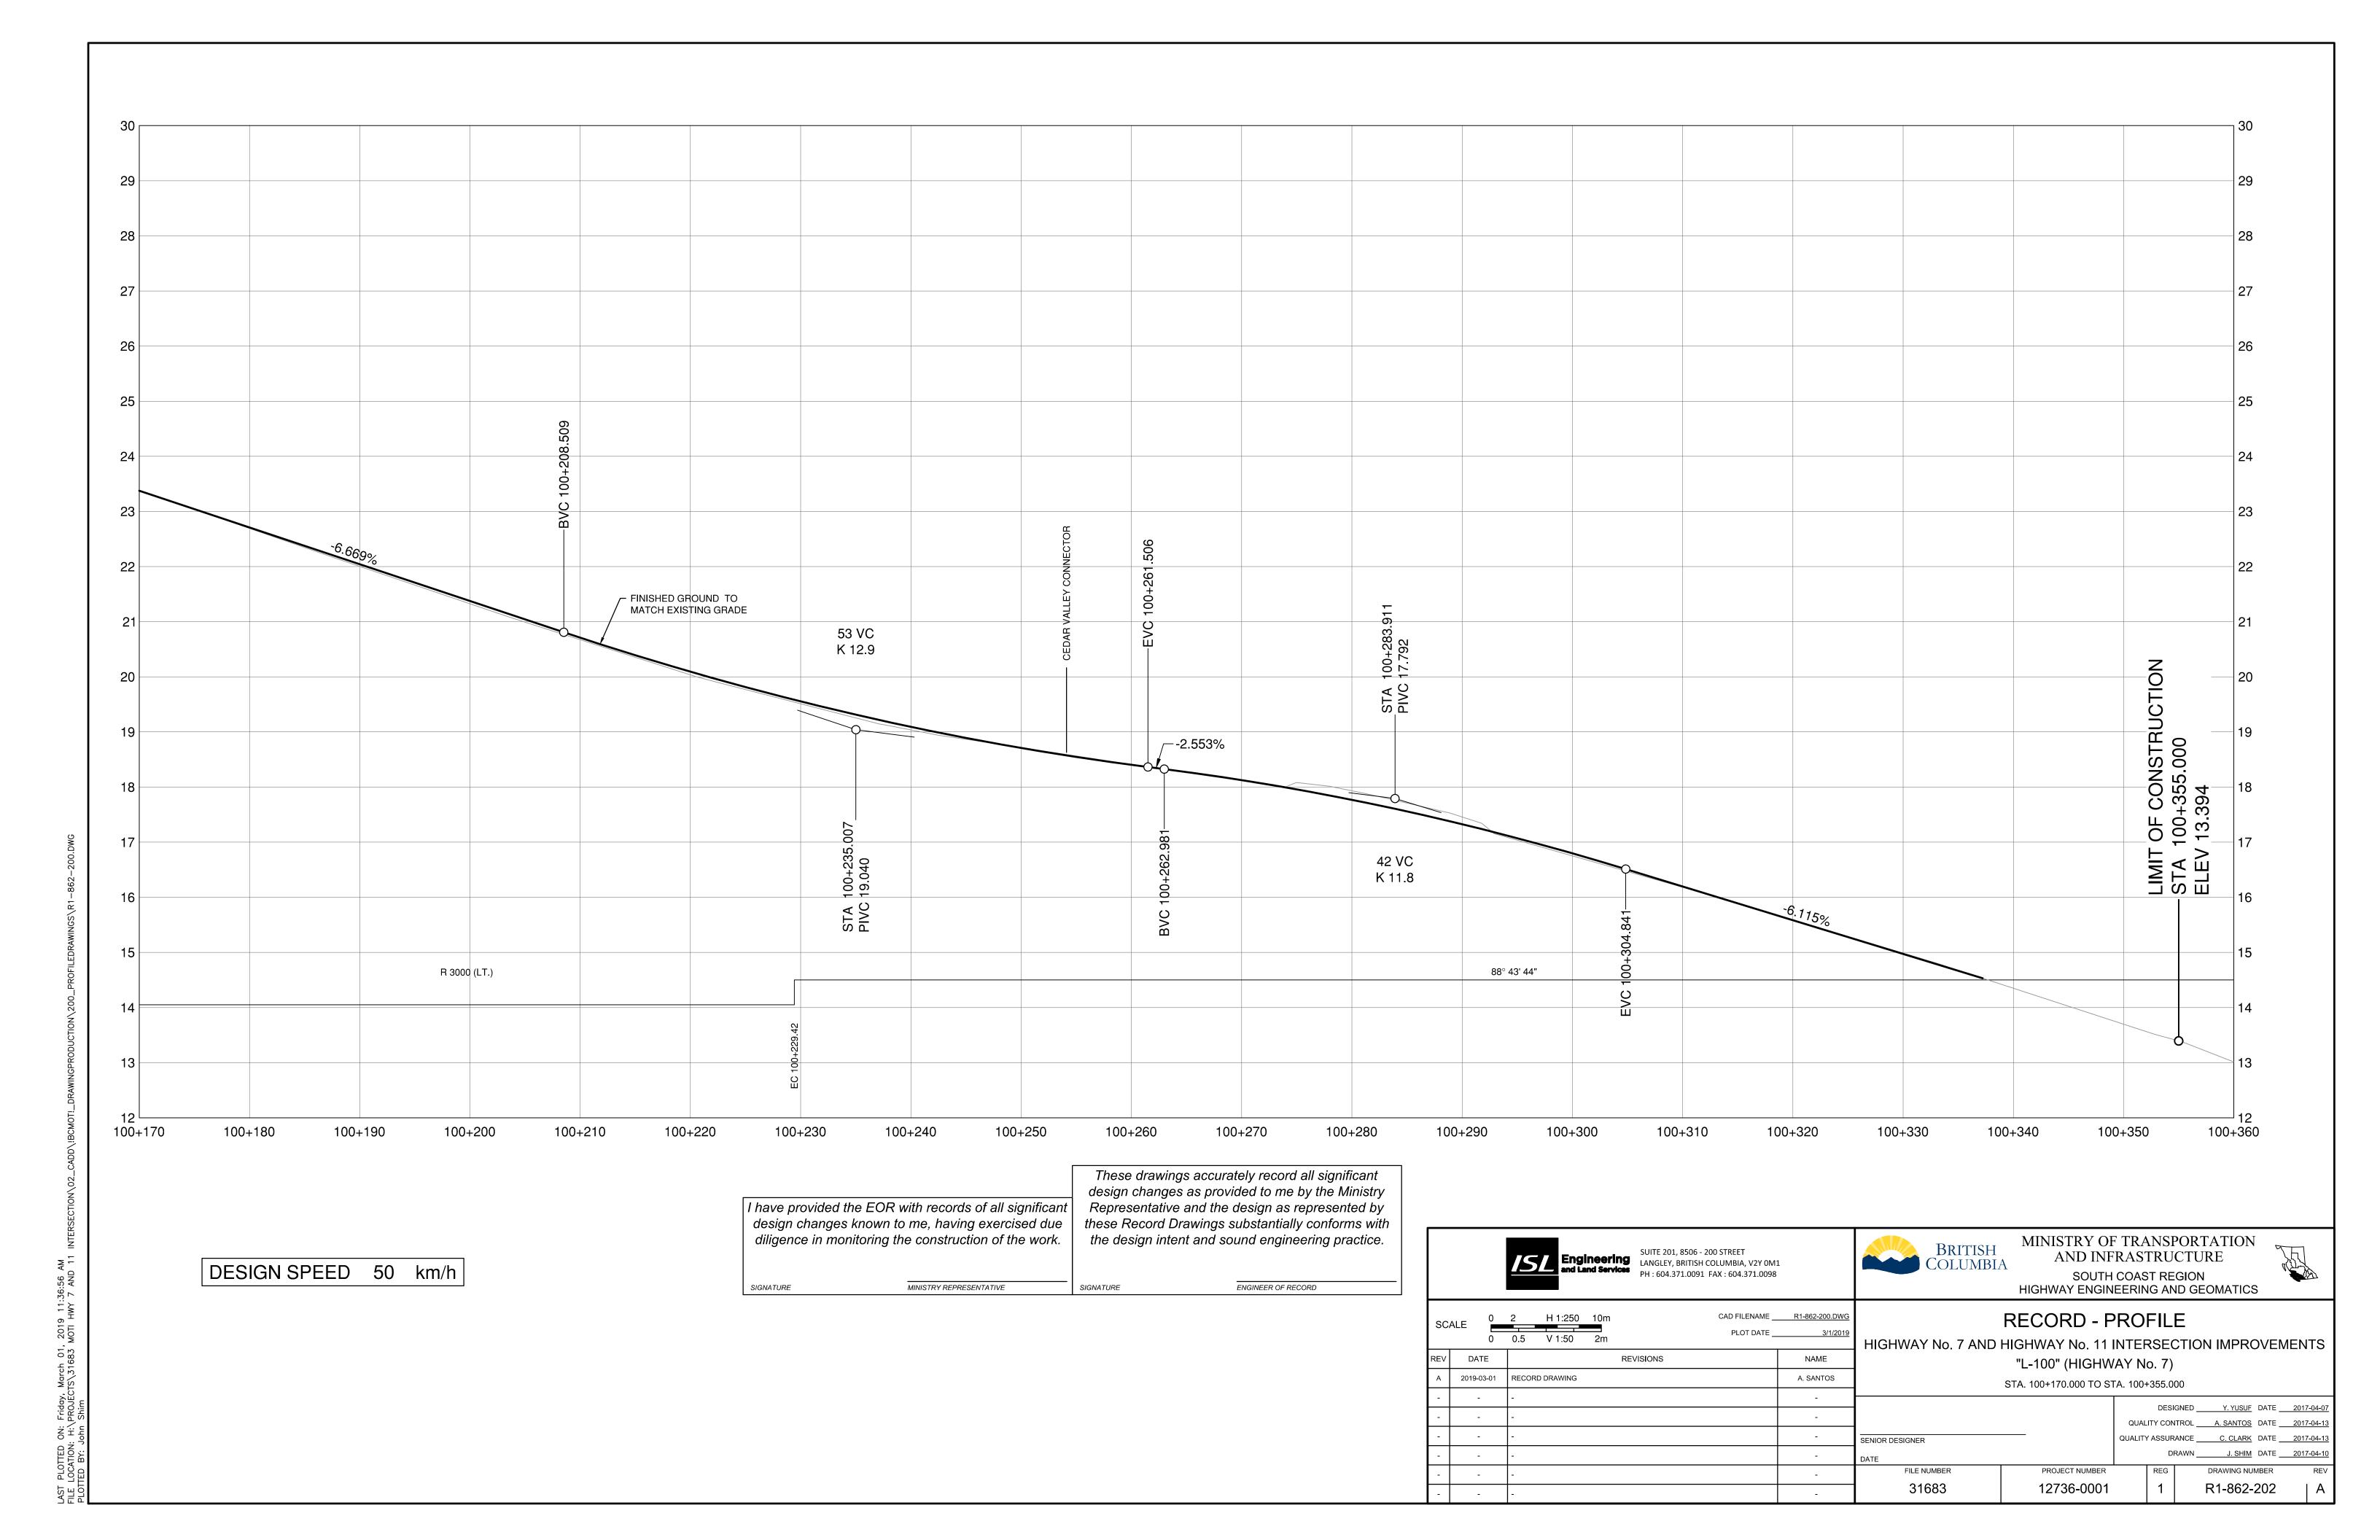
HIGHWAY No. 7 AND HIGHWAY No. 11 INTERSECTION IMPROVEMENTS HIGHWAY 7 AND 11

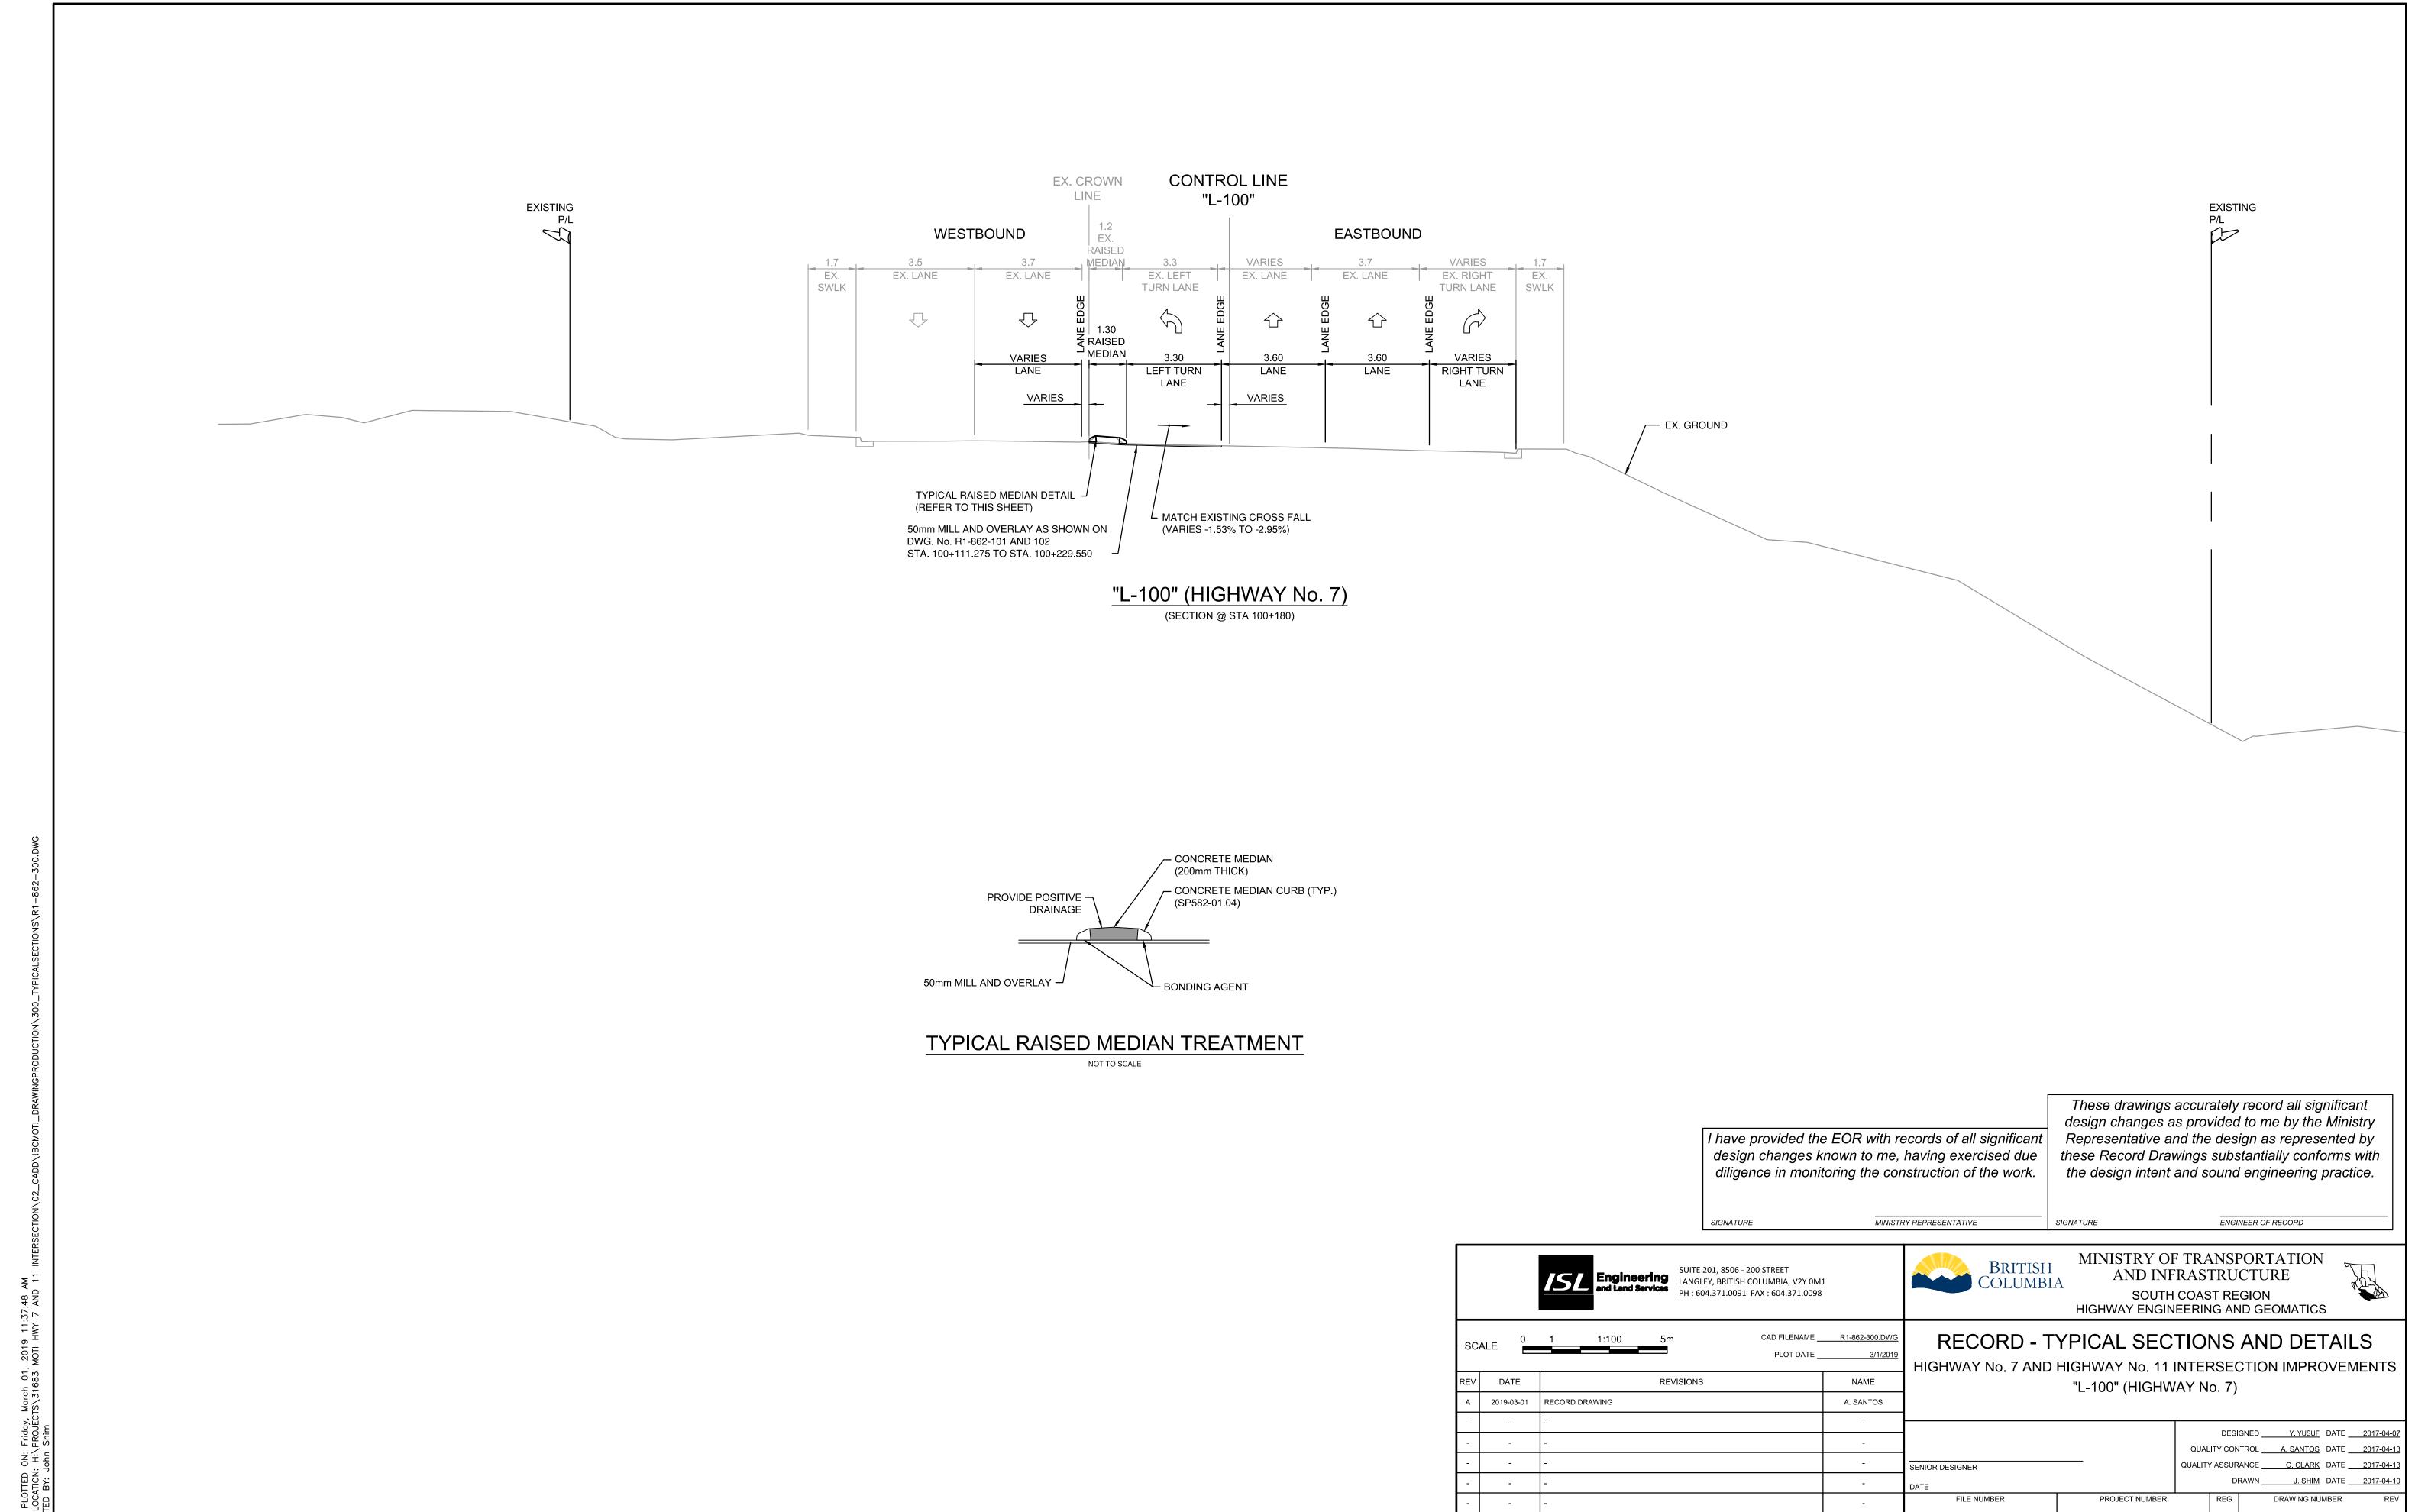
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PROJECT NUMBER

12736-0001

DRAWING NUMBER

R1-862-301

